


7 North Bog Road

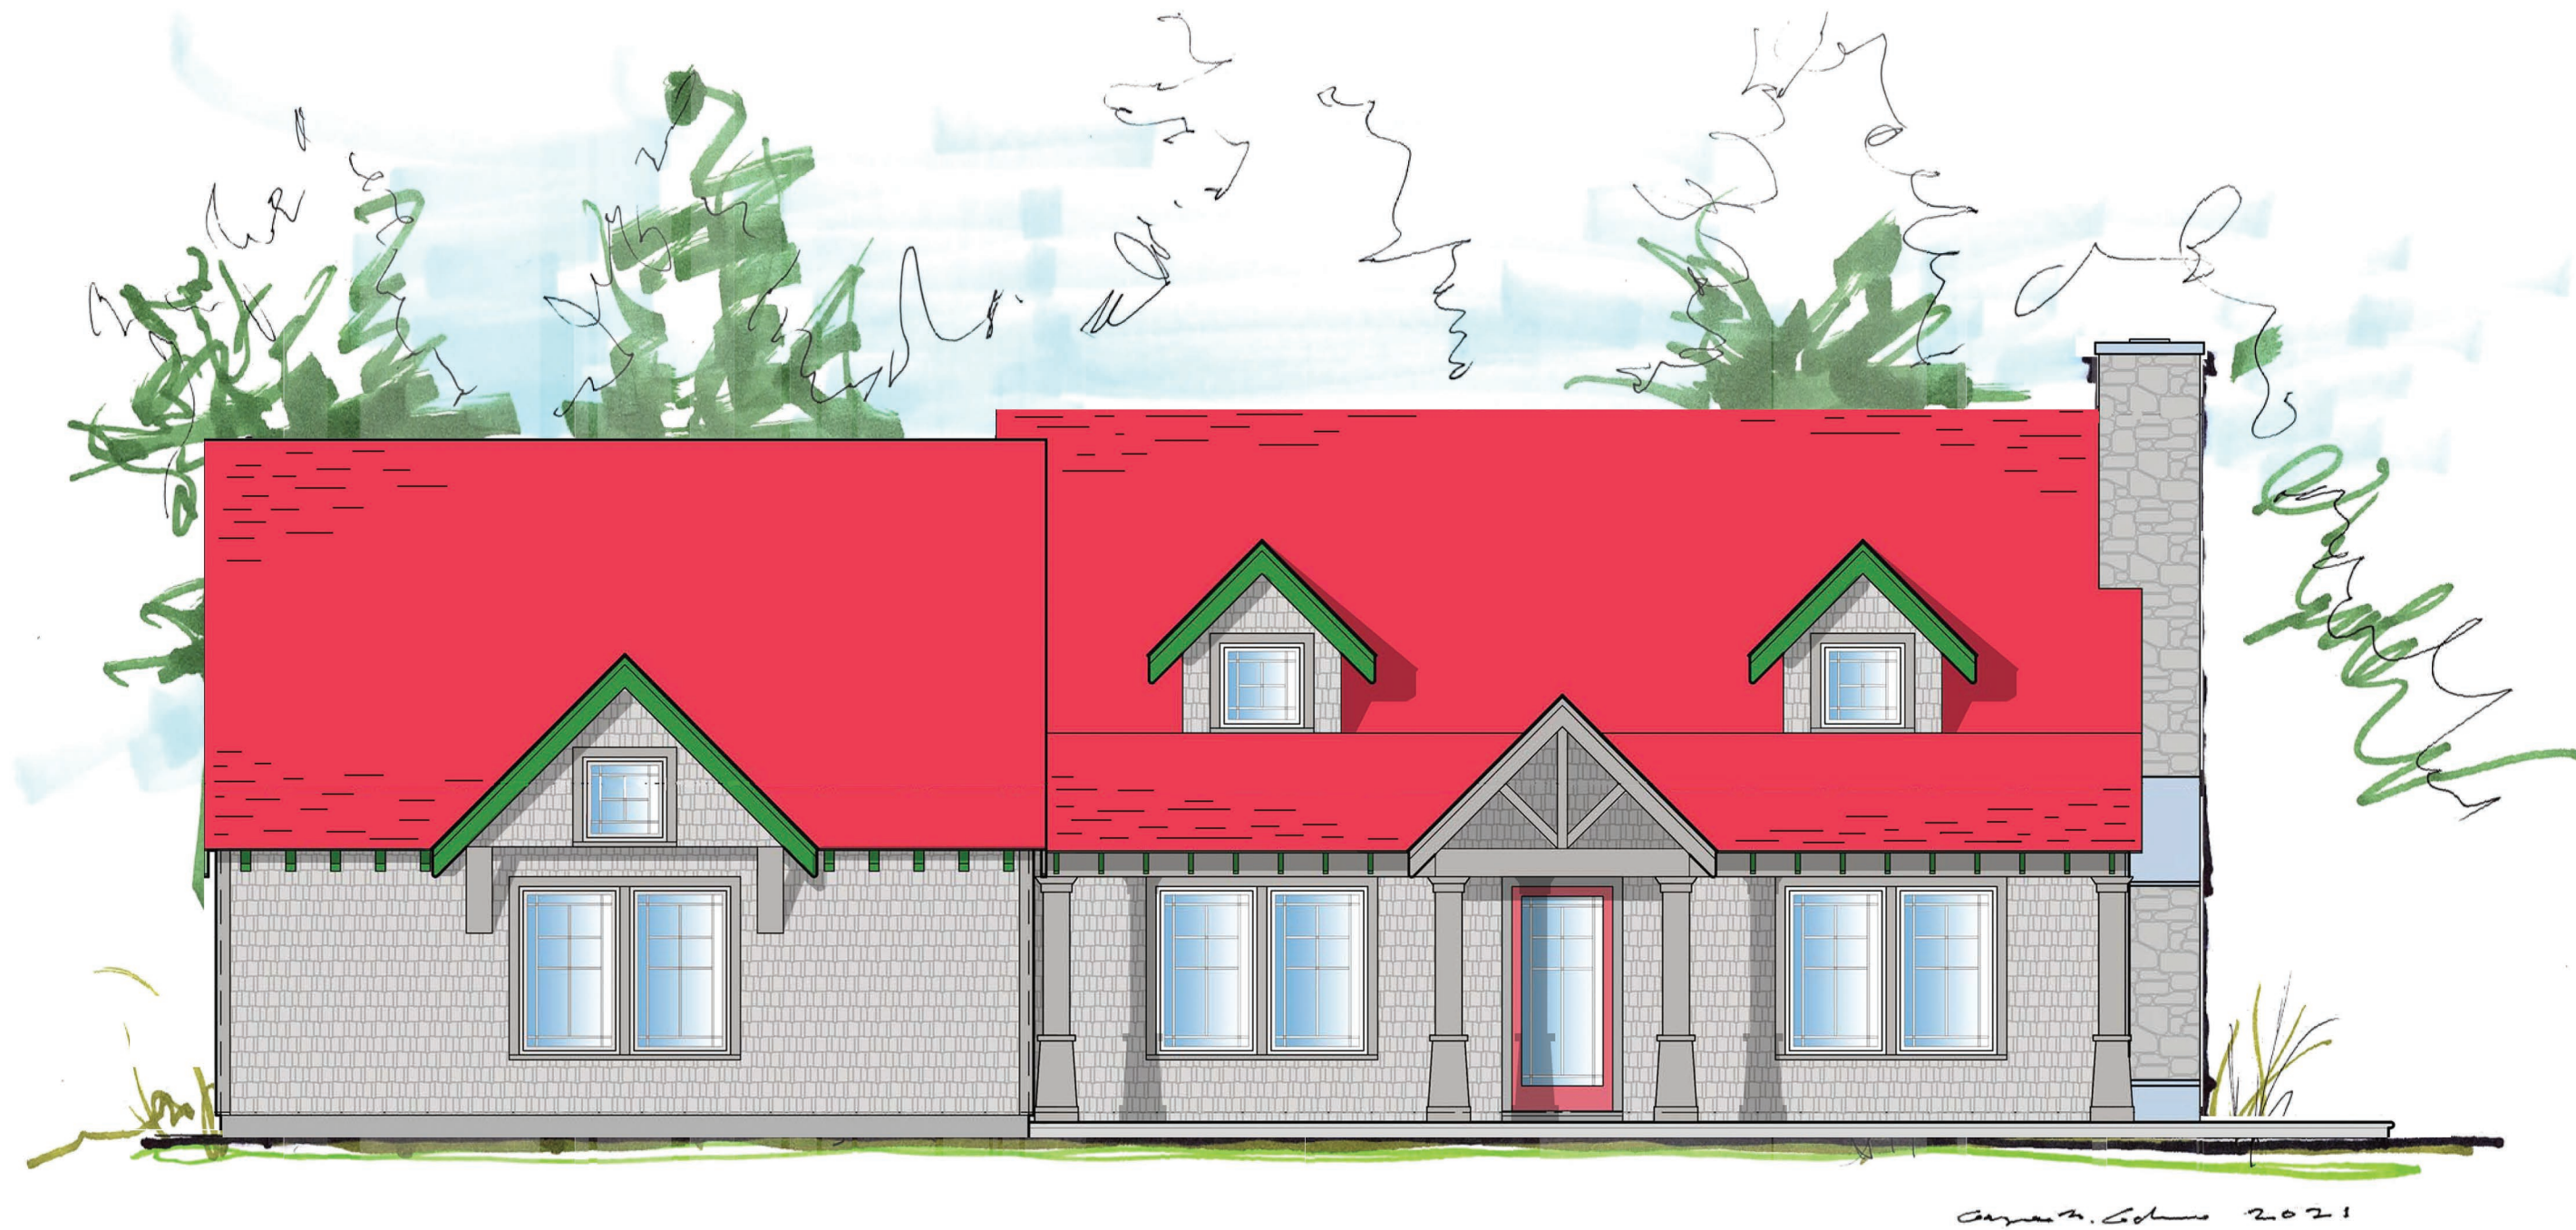

Project
7 North Bog Road
Edgartown, MA 02539

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LOCUS MAP

GRAPHIC SYMBOLS

	EARTH
	GRAVEL/COMP. FILL
	ROCKLEDGE
	CONCRETE
	BRICK
	CONCRETE BLOCK
	STONE
	STEEL Large Scale Small Scale
	FINISHED WOOD
	ROUGH WOOD Dimensional Lumber Only
	BLOCKING Misc. sized wood
	PLYWOOD Large Scale Small Scale
	PARTICLE BOARD
	GLASS Large Scale Small Scale
	GYPSUM BOARD
	ALUMINUM

DRAWING SYMBOLS

	COLUMN GRID Column Or Grid Number
	DETAILS Detail Number Drawing Shown On (Only if NOT Same Dwg.)
	SECTION Section Number Drawing Shown On
	WALL TYPES Detail Number
	DOOR NUMBER Door Number Letter Used if More Than One Door into Space
	WINDOW TYPE Window Type
	CEILING HEIGHTS Finish Ceiling Elevations
	NOTATIONS Notation Reference Number (Demolition Note)
	DETAIL AREA Enlarged Detail Area Detail Number Drawing Shown On
	EQUIPMENT Equipment Reference Number
	NORTH ARROW True North Plan North (Project Reference)
	REVISIONS Revision Location

ARCHITECTURAL ABBREVIATIONS

SYMBOLS used as abbreviations:

angle L
centerline C
channel L
round B

ABBREVIATIONS:

AFF above finished floor
AC acoustical
ACT acoustical tile
ADJ adjacent
ADJT adjustable
ALT alternate
ALUM aluminum
ANC anchor, anchorage
AB anchor bolt
ASPH asphalt

BSMT basement
BRG bearing
BEL below
BET between
BIT bluish
BLKG blocking
BD board
BOT bottom
BRK brick
BLDG building

CAB cabinet
CPT carpet (ed)
CB catch basin
CLG ceiling
CEM cement
CER ceramic
CT ceramic tile
CIR circle
CIRC circumference
CO cleanout
CLR clear (space)
COL column
COMB combination
CMP compress (ed), (con), (bie)
CONC concrete
CMU concrete masonry unit
CONST construction
CONT continuous
CJ control joint
CIR counter
CRS course

DEP depressed
DTL detail
DIAG diagonal
DIA diameter
DIM dimension
DR door
DH double hung
DWR drawer
DWG drawing
DW dishwasher

EF each face
ELEC electric (all)
EWC electric water cooler
EL elevation
ELEV elevator
ENCL enclosure
EQ equal
EXH exhaust
EXG existing
EXP exposed
EXT exterior

FOF face of finish
FF finish floor
FA fire alarm
FEC fire extinguisher cabinet
FHC fire hose cabinet
FP fireproof
FLR floor (ing)
FD floor drain
FLUOR fluorescent
FTG footing
FND foundation
FBO furnished by others
FUR furred (ing)

GA gage, gauge
GALV galvanized
GL glass, glazing
GB grab bar
GO grade
GYP gypsum

HDWR hardware
HDR header
HD heavy duty
HT height
HM hollow metal
HOR horizontal

INCL include (d), (ing)
ID inside diameter
INS insulate (d), (con)
INT interior
INTM intermediate
INV invert

JT joint

KO knockout

LBL label
LAB laboratory
LAV lavatory
LH left hand
L length
LT light
LW light weight
L.C.C. lead coated copper

MH manhole
MAS masonry
MO masonry opening
MAX maximum
MECH mechanical
MED medium
MTL metal
MN minimum
MR mirror
MSC miscellaneous
MLD molding
MTD mount (ed)

NAT natural
NOM nominal
NC not in contract
NTS not to scale

OC on center (s)
OPG opening
OPP opposite
OD outside diameter
OA overall
OH overhead

PNT paint (ed)
PNL panel
PTD paper towel dispenser
PAR parallel
PVMT pavement
PERIM perimeter
PLAS plaster
PLAM plastic laminate
PL plate
PLWD plywood
PT pressure treated

QT quarry tile

REF reference
REFR refrigerator
REN reinforce (d)
RES resilient
RA return air
REV revision (s), revised
RH right hand
R riser
RD roof drain
RFG roofing
RM room
RO rough opening

SCH schedule
SEC section
SHT sheet
SIM similar
SC solid core
SQ square
SS stainless steel
STL steel
STR structural
SUSP suspended
SYM symmetry (cal)
SYS system

TEL telephone
TV television
TRK track (ness)
TPD toilet paper dispenser
T&G tongue and groove
TOC top of concrete
TOS top of steel
TOW top of wall
T tread
TRTD treated
TYP typical

UC undercut
UNO unless noted otherwise
UR urinal

VB vapor barrier
VNR veneer
VERT vertical
VCT vinyl composition tile
VIF verify in field

WH wall hung
WC water closet
WP waterproof (ing)
WWM welded wire mesh
W width, wide
WN window
WG wire glass
WO without

DRAWING INDEX

ARCHITECTURAL DRAWINGS:

A0.0 COVER SHEET, DRAWING INDEX, PROJECT DATA
A1.0 FIRST FLOOR & LOFT PLAN
A2.0 ALL ELEVATIONS
A3.0 BUILDING SECTIONS & DETAILS

STRUCTURAL DRAWINGS:

S0.1 FOUNDATION PLAN
S1.0 FIRST FLOOR & LOFT FRAMING PLAN
S2.0 ROOF FRAMING PLAN
S3.0 NAILING SCHEDULE

CODE COMPLIANCE

ALL WORK SHALL CONFORM TO CURRENT BUILDING CODES, FEDERAL, STATE AND LOCAL CODE REQUIREMENTS, LAWS AND ORDINANCES.

COMPLIANCE WITH CURRENT VERSIONS OF THE FOLLOWING CODES AND AGENCIES ARE REQUIRED:

2015
IBC - International Residential Building Code
IEBC - International Existing Building Code
IECC - International Energy Conservation Code
IMC - International Mechanical Code
IFC - International Fire Code

780 CMR - MA Amendments to the IBC
527 CMR - MA fire prevention and electrical regulations
521 CMR - MA accessibility regulations
248 CMR - MA plumbing regulations
524 CMR - MA elevator regulations

STATE OF MASSACHUSETTS BUILDING CODE 9th EDITION
DUKES COUNTY AND TOWN OF EDGARTOWN

Issued For

REV.	ISSUE	DATE

DESIGN DEVELOPMENT

COVER SHEET, DRAWING INDEX, PROJECT DATA

Drawing Title: _____

Drawn By: CT Checked By: GG

A0.0

Drawing Number: _____

File Name: _____ Scale: AS NOTED


Date: 6/24/2021

Project
7 North Bog Road


Edgartown, MA
02539

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1 First Floor Plan
Scale: 1/4" = 1'-0"

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DESIGN DEVELOPMENT

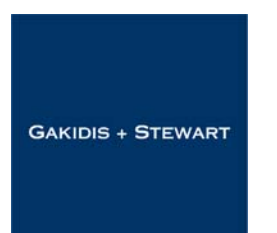FIRST FLOOR PLAN

Drawing Title:
Drawn By: CG Checked By: GG

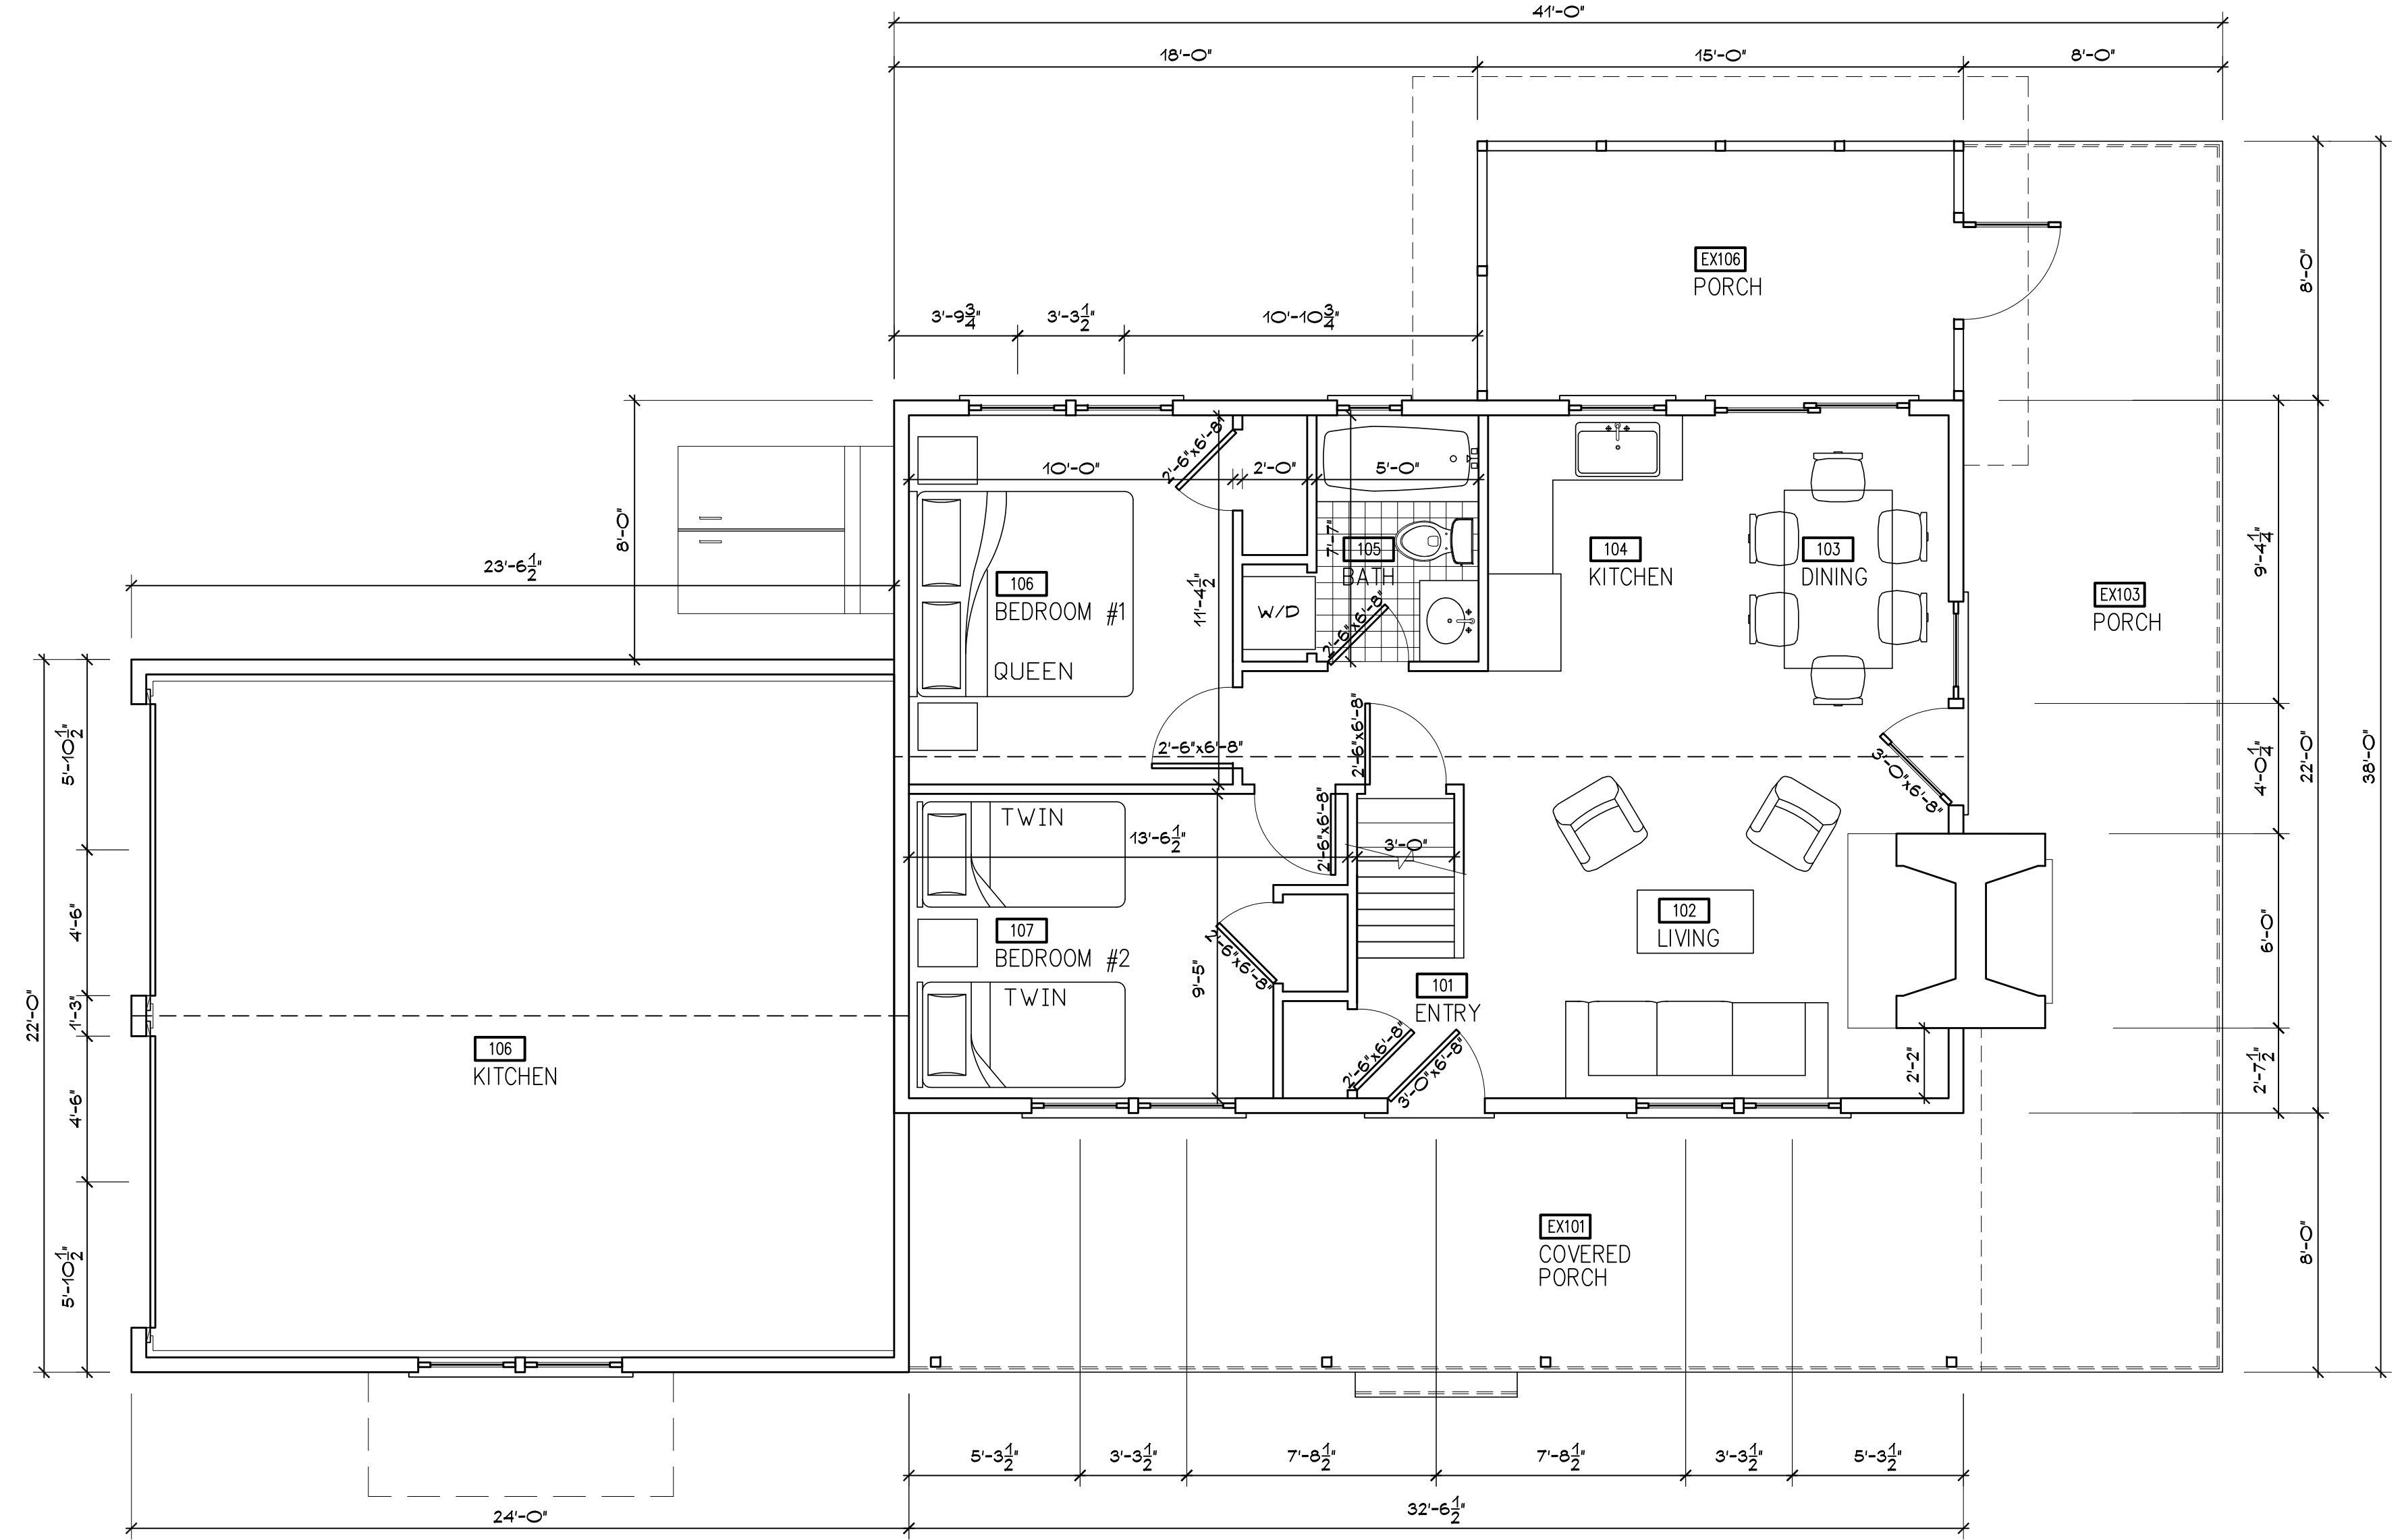A1.0

Drawing Number:
File Name: Scale: AS NOTED
Date: 6/24/2021

Project

7 North Bog Road

Edgartown, MA
02539

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LOFT PLAN

Drawing Title:


Drawn By: CG Checked By: GG

A1.2

Drawing Number:

File Name: Scale: AS NOTED

Date: 6/24/2021

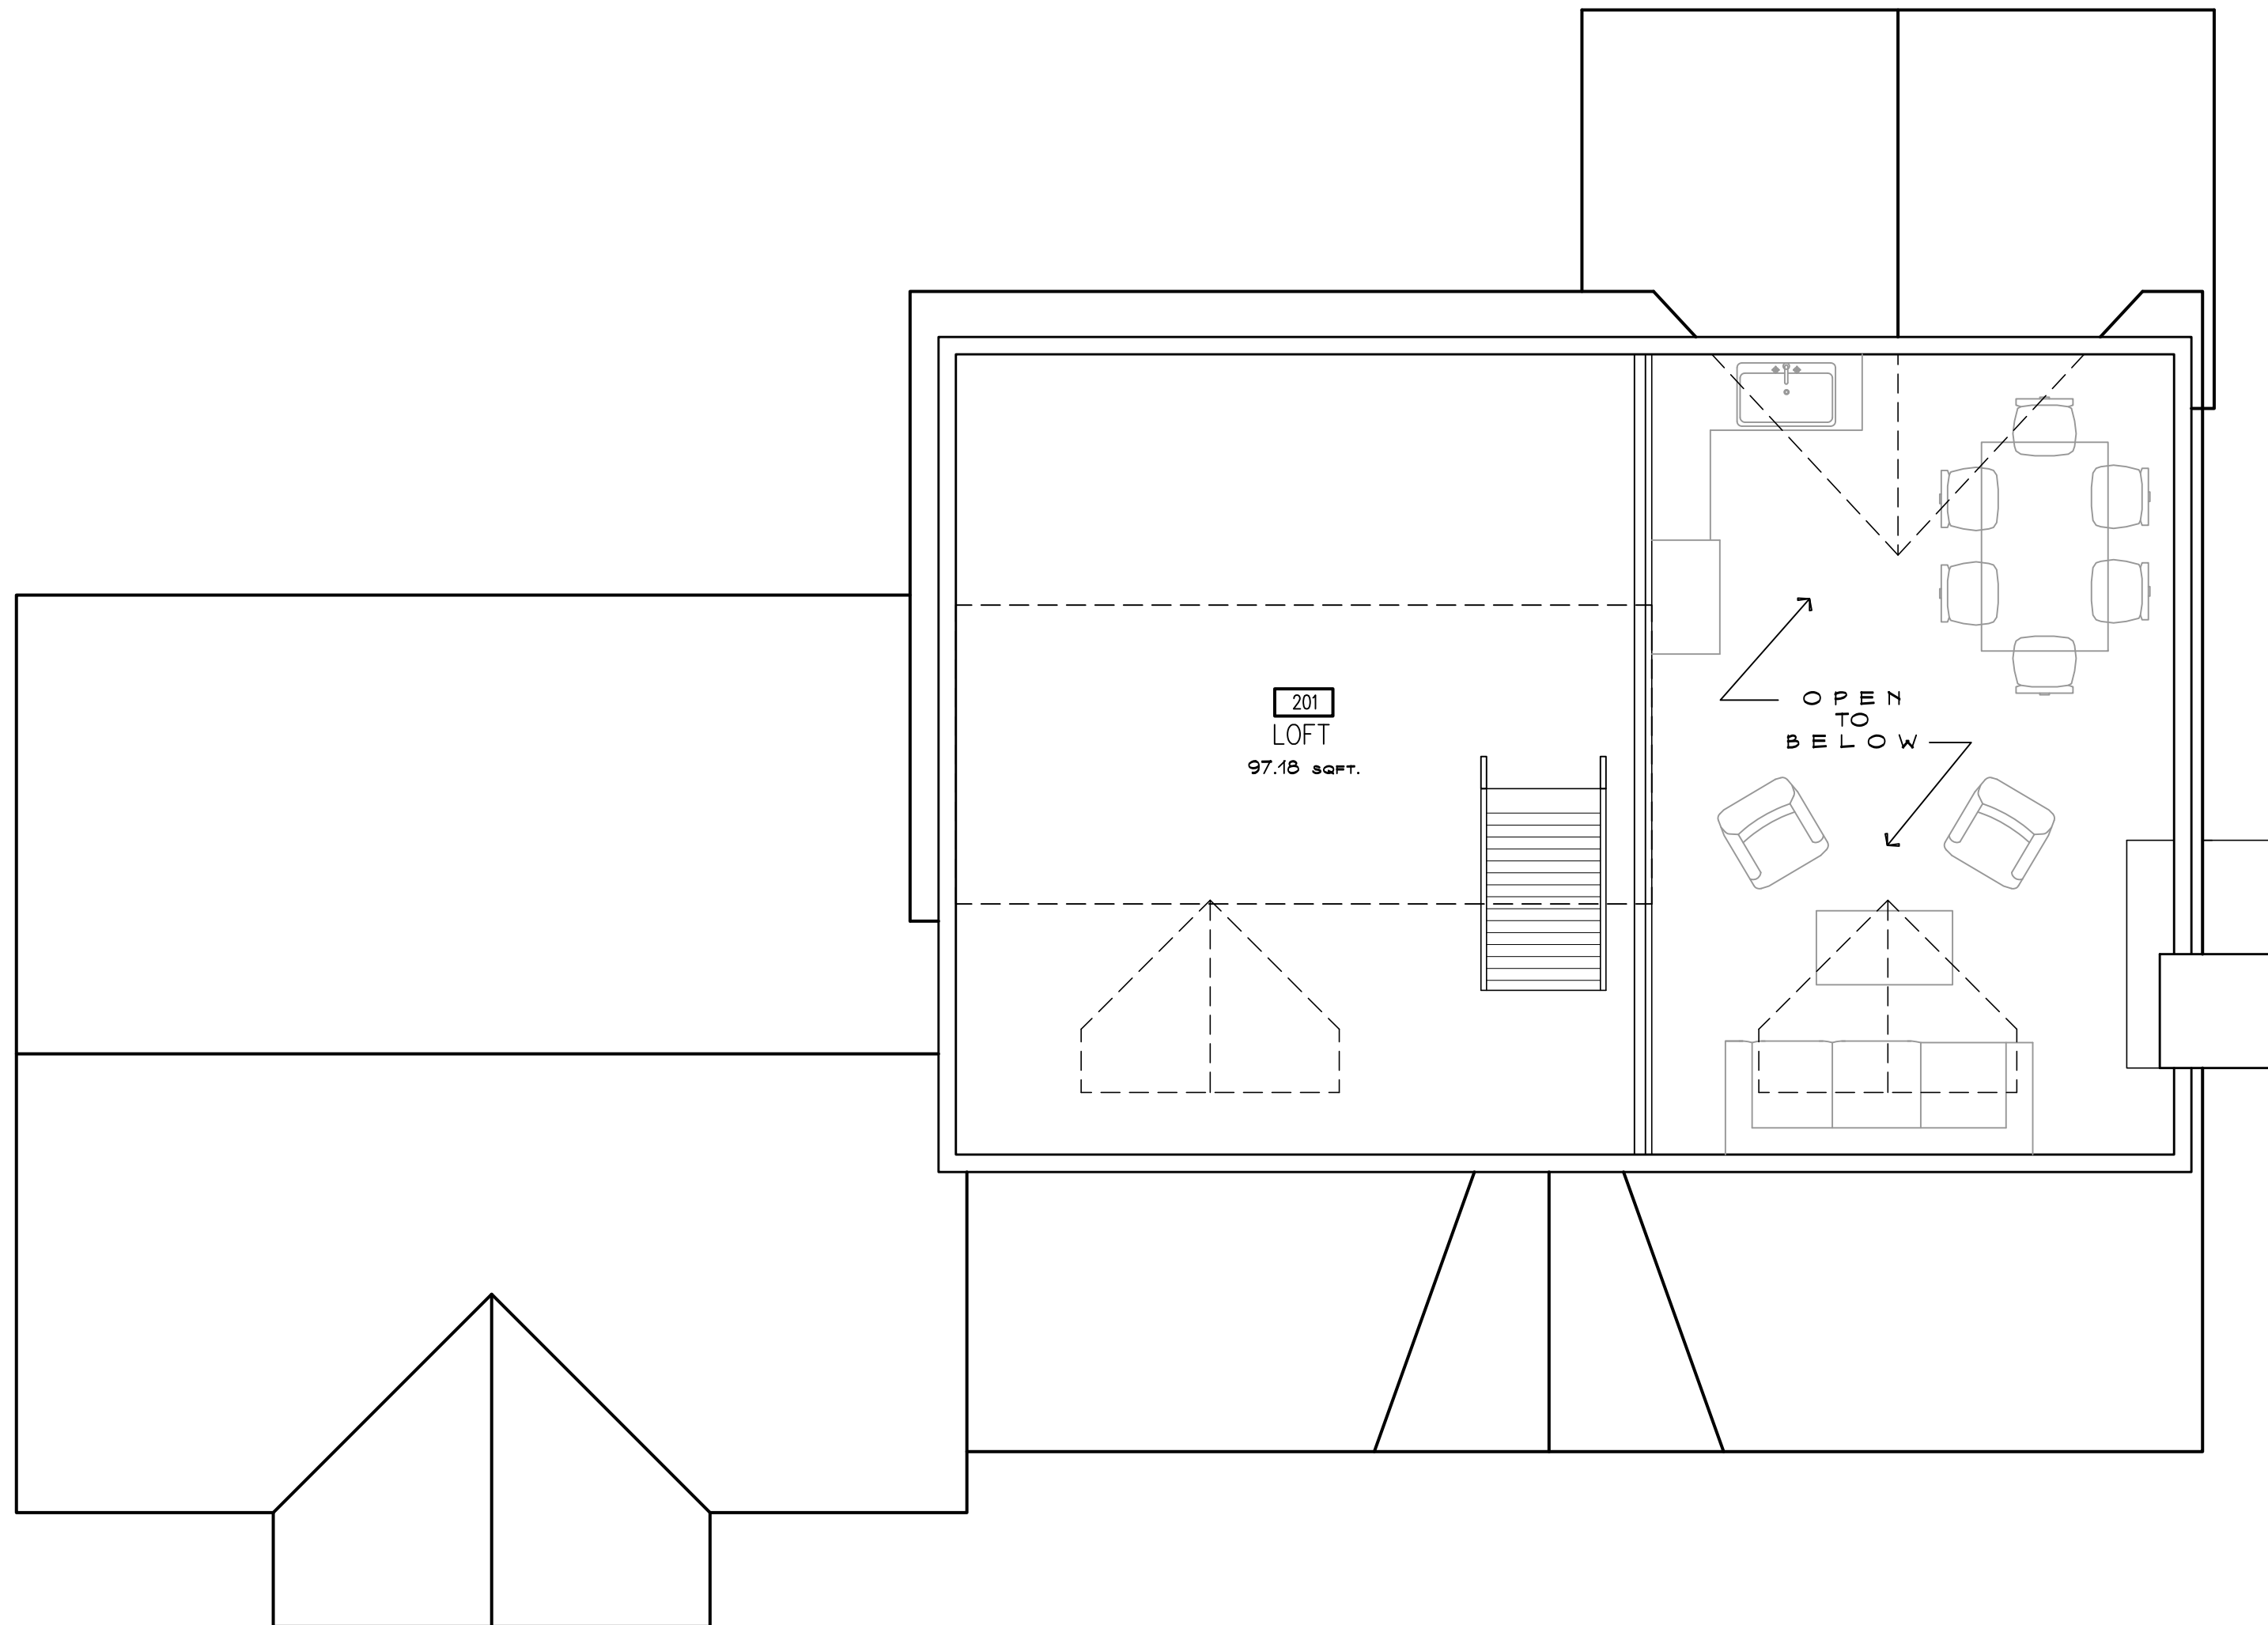

1 Loft Plan
Scale: 1/4" = 1'-0"

GENERAL NOTE:
ALL WINDOWS AND DOORS TO MATCH
EXISTING. USE PELLA RESERVE SERIES
SIZING FOR PRICING, CASING 1X4 W/
BAND MOLDING & APPLIED SUBSILL
NON IMPACT GLASS AND
CORRELATING NUMBERED PLYWD
BARRIER PANELS

PLUMBING STACKS, BATHROOM
EXHAUST, KITCHEN EXHAUST, ETC.
LOCATIONS TO BE REVIEWED AND
APPROVED BY GS DESIGN GROUP,
INC. BEFORE INSTALLATION

NOTE:
ALL EXTERIOR TRIM, BRACKETS,
MOLDINGS, ETC., SHALL BE KOMA
ALL EXPOSED SURFACE SHALL
RECEIVE (1) COAT MFR.
RECOMMENDED PRIMER AND (1) COAT
SHERMAN WILLIAMS DURATION SERIES
OR EQUAL LATEX PAINT. ALL JOINTS
AND ADJOINING PARALLEL SURFACES
TOUCHING TO BE GLUED W/ MFR
APPROVED 2 PART EPOXY
GLUE/WELD ALL NAIL HOLES TO BE
FILLED W/ BOND AND FILL' TRIM STICK
PVC PUTTY OR EQUAL.

Project
**7 North Bog
Road**


Edgartown, MA
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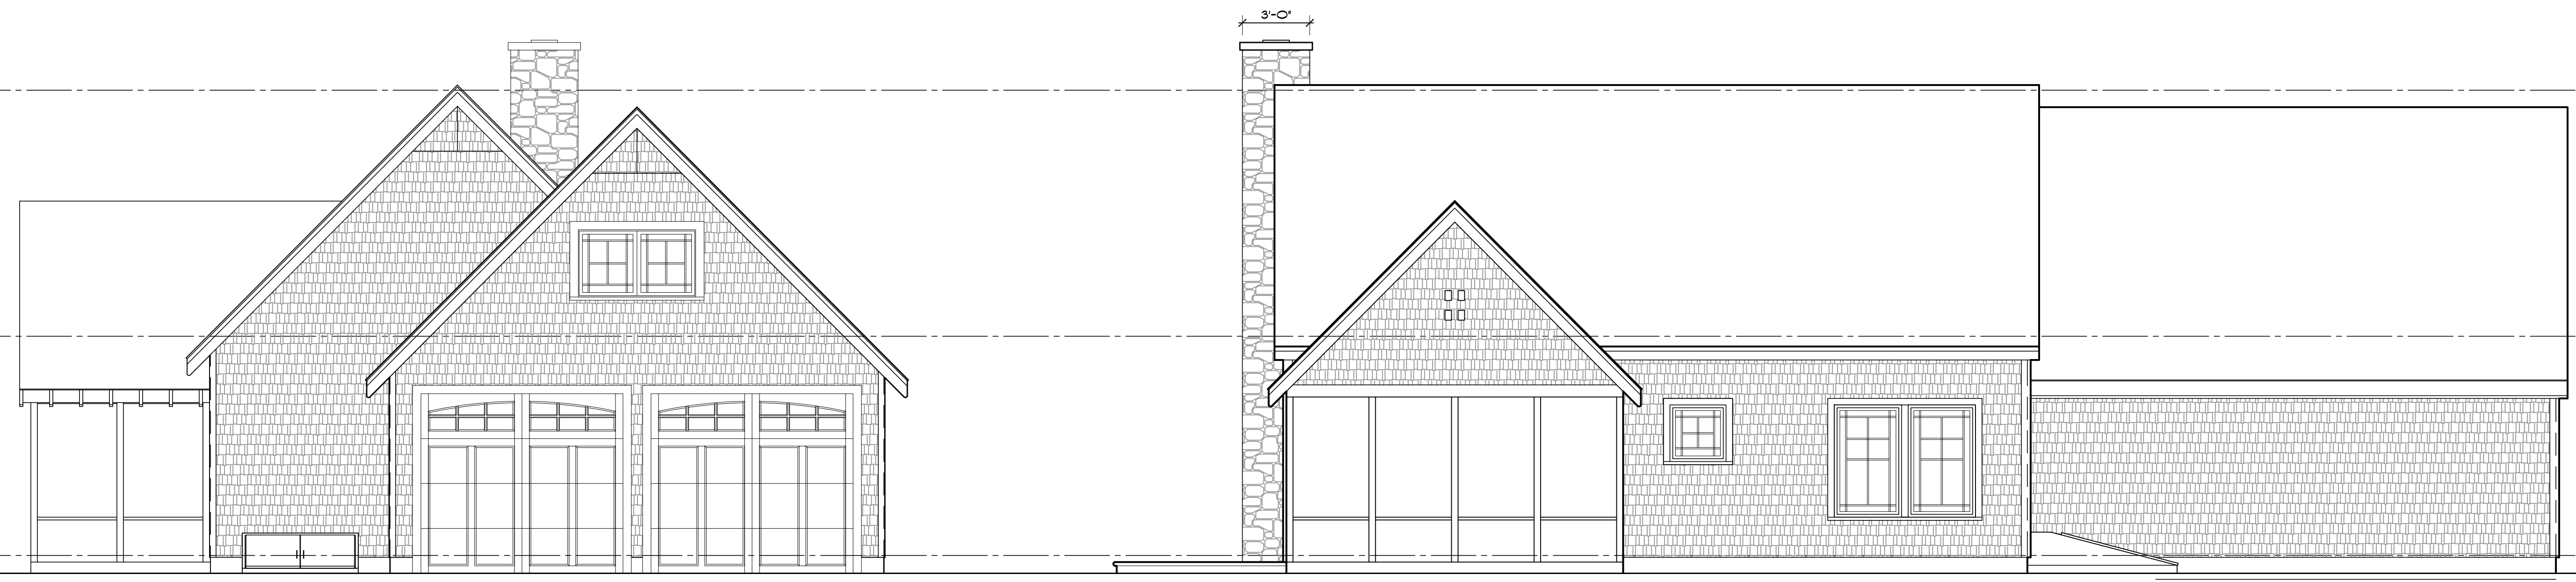


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Front Elevation Scale: 1/4" = 1'- 0"

1



Side Elevation Scale: 1/4" = 1'- 0"

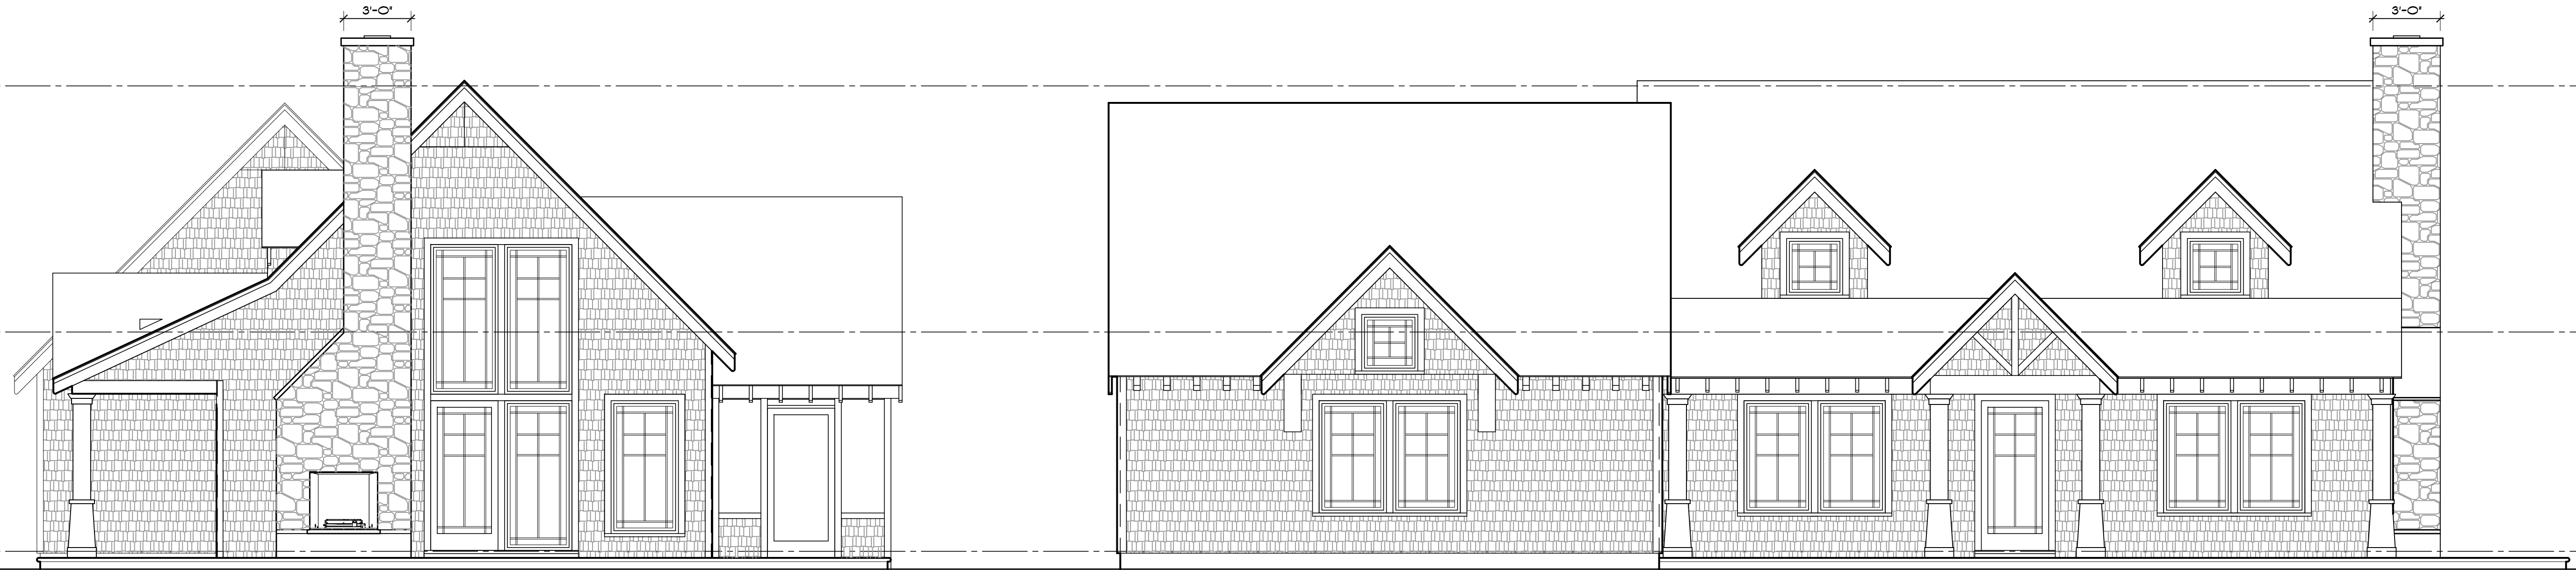2



Front Elevation Scale: 1/4" = 1'- 0"

3

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**DESIGN
DEVELOPMENT**

ELEVATIONS

Drawing Title:
Drawn By: CT Checked By: GG

A2.0

Drawing Number:
File Name: Scale: AS NOTED
Date: 6/24/2021

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 SIZING FOR PRICING, CASING 1X4 W/
 BAND MOLDING & APPLIED SUBSILL
 NON IMPACT GLASS AND
 CORRELATING NUMBERED PLYWD
 BARRIER PANELS

**PLUMBING STACKS, BATHROOM
 EXHAUST, KITCHEN EXHAUST, ETC.
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 RECOMMENDED PRIMER AND (1) COAT
 SHERMAN WILLIAMS DURATION SERIES
 OR EQUAL LATEX PAINT. ALL JOINTS
 AND ADJOINING PARALLEL SURFACES
 TOUCHING TO BE GLUED W/ MFR
 APPROVED 2 PART EPOXY
 GLUE/WELD ALL NAIL HOLES TO BE
 FILLED W/BOND AND FILL TRIM STICK
 PVC PUTTY OR EQUAL.

Project
**7 North Bog
 Road**
 Edgartown, MA
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Front Elevation Scale: 1/4" = 1'-0"

1



Side Elevation Scale: 1/4" = 1'-0"

2

Front Elevation Scale: 1/4" = 1'-0"

3

Issued For		
REV.	ISSUE	DATE

**DESIGN
 DEVELOPMENT**

ELEVATIONS

Drawing Title:
 Drawn By: CT Checked By: GG

A2.0



Drawing Number:
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Garage Section

Scale: 1/4" = 1'- 0"

1

Building Section

Scale: 1/4" = 1'- 0"

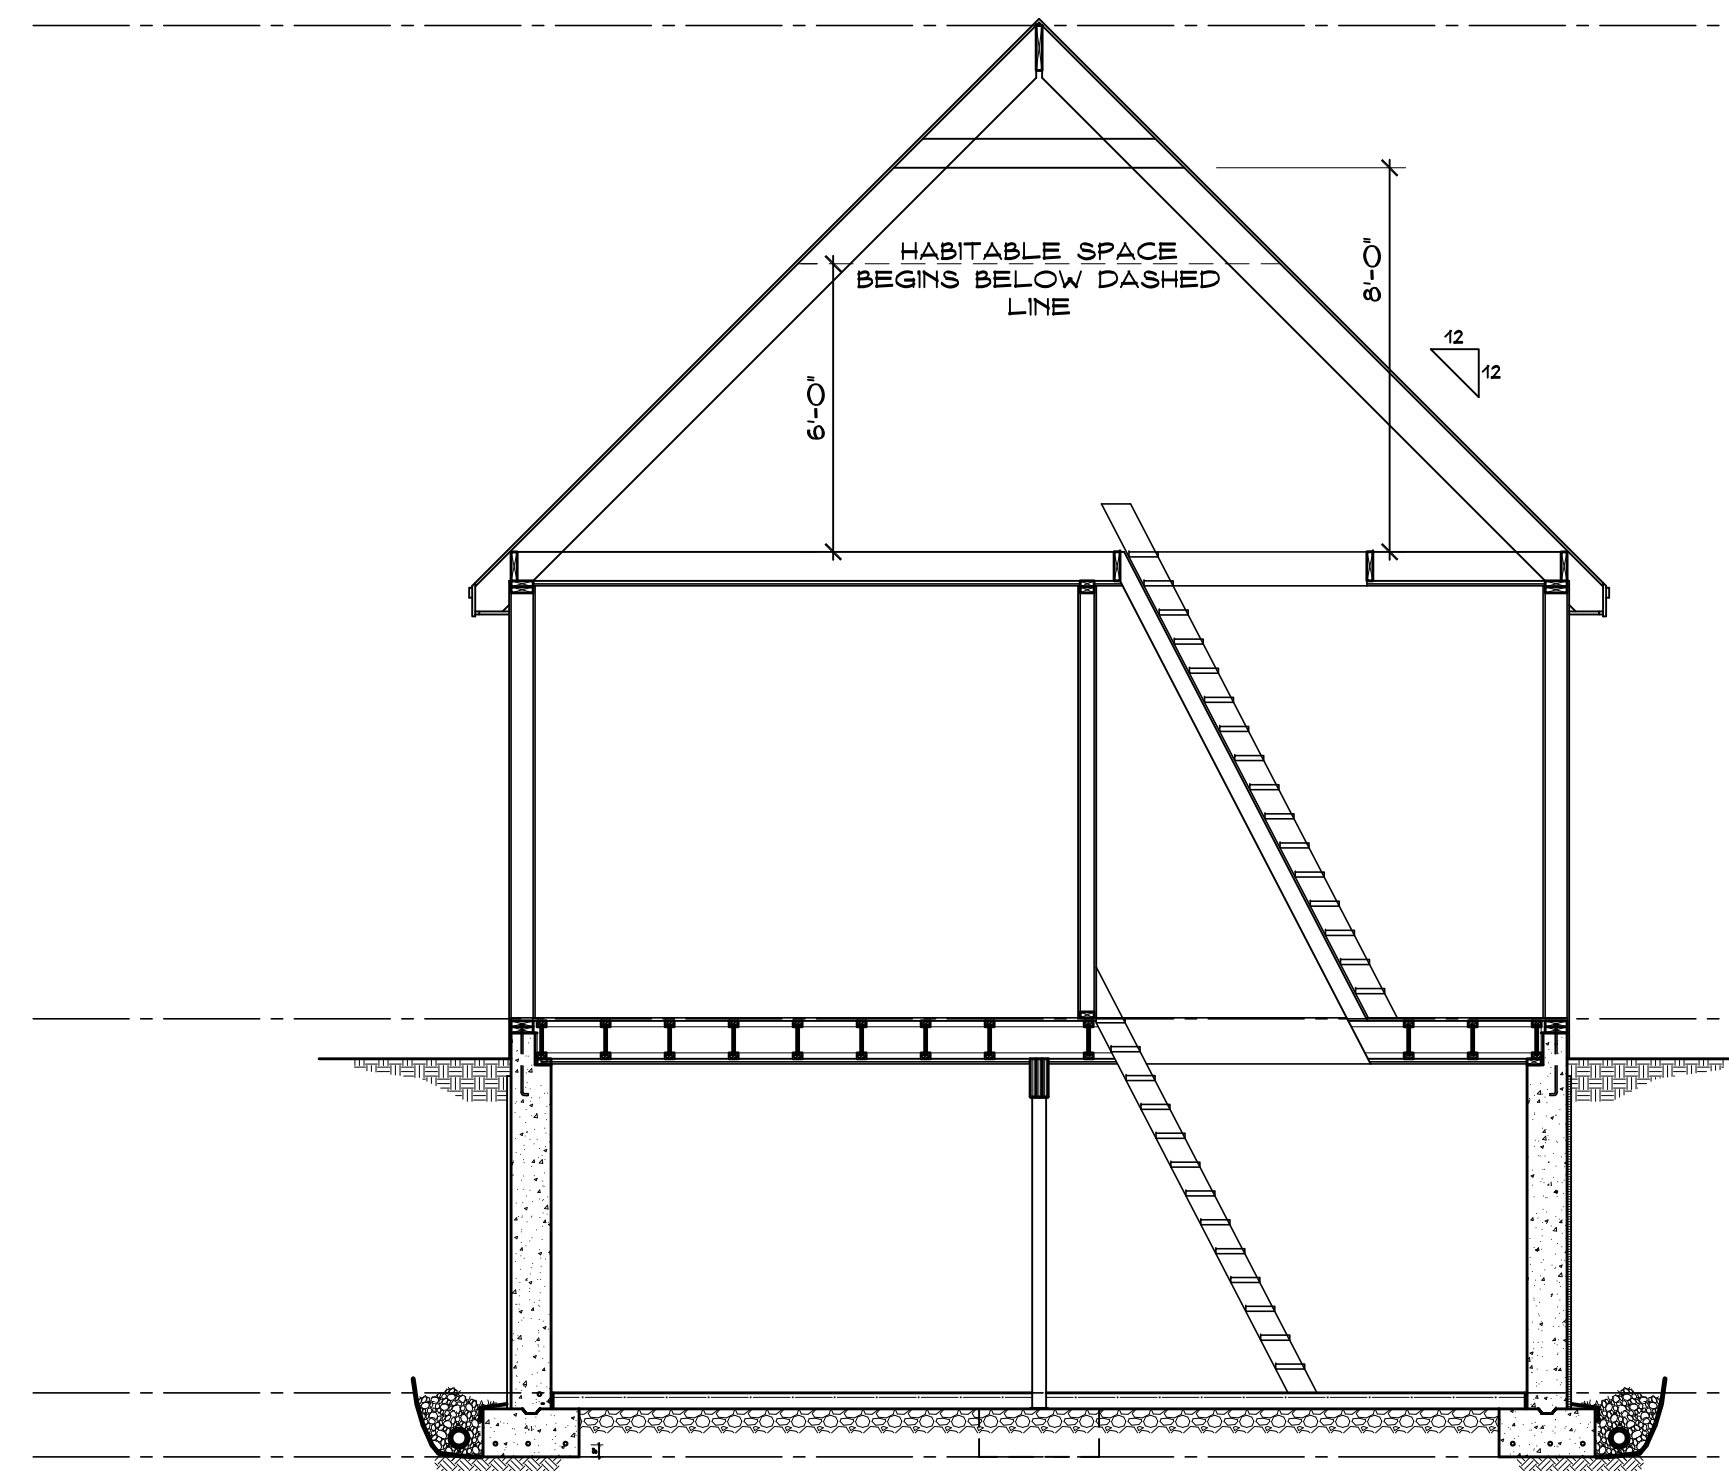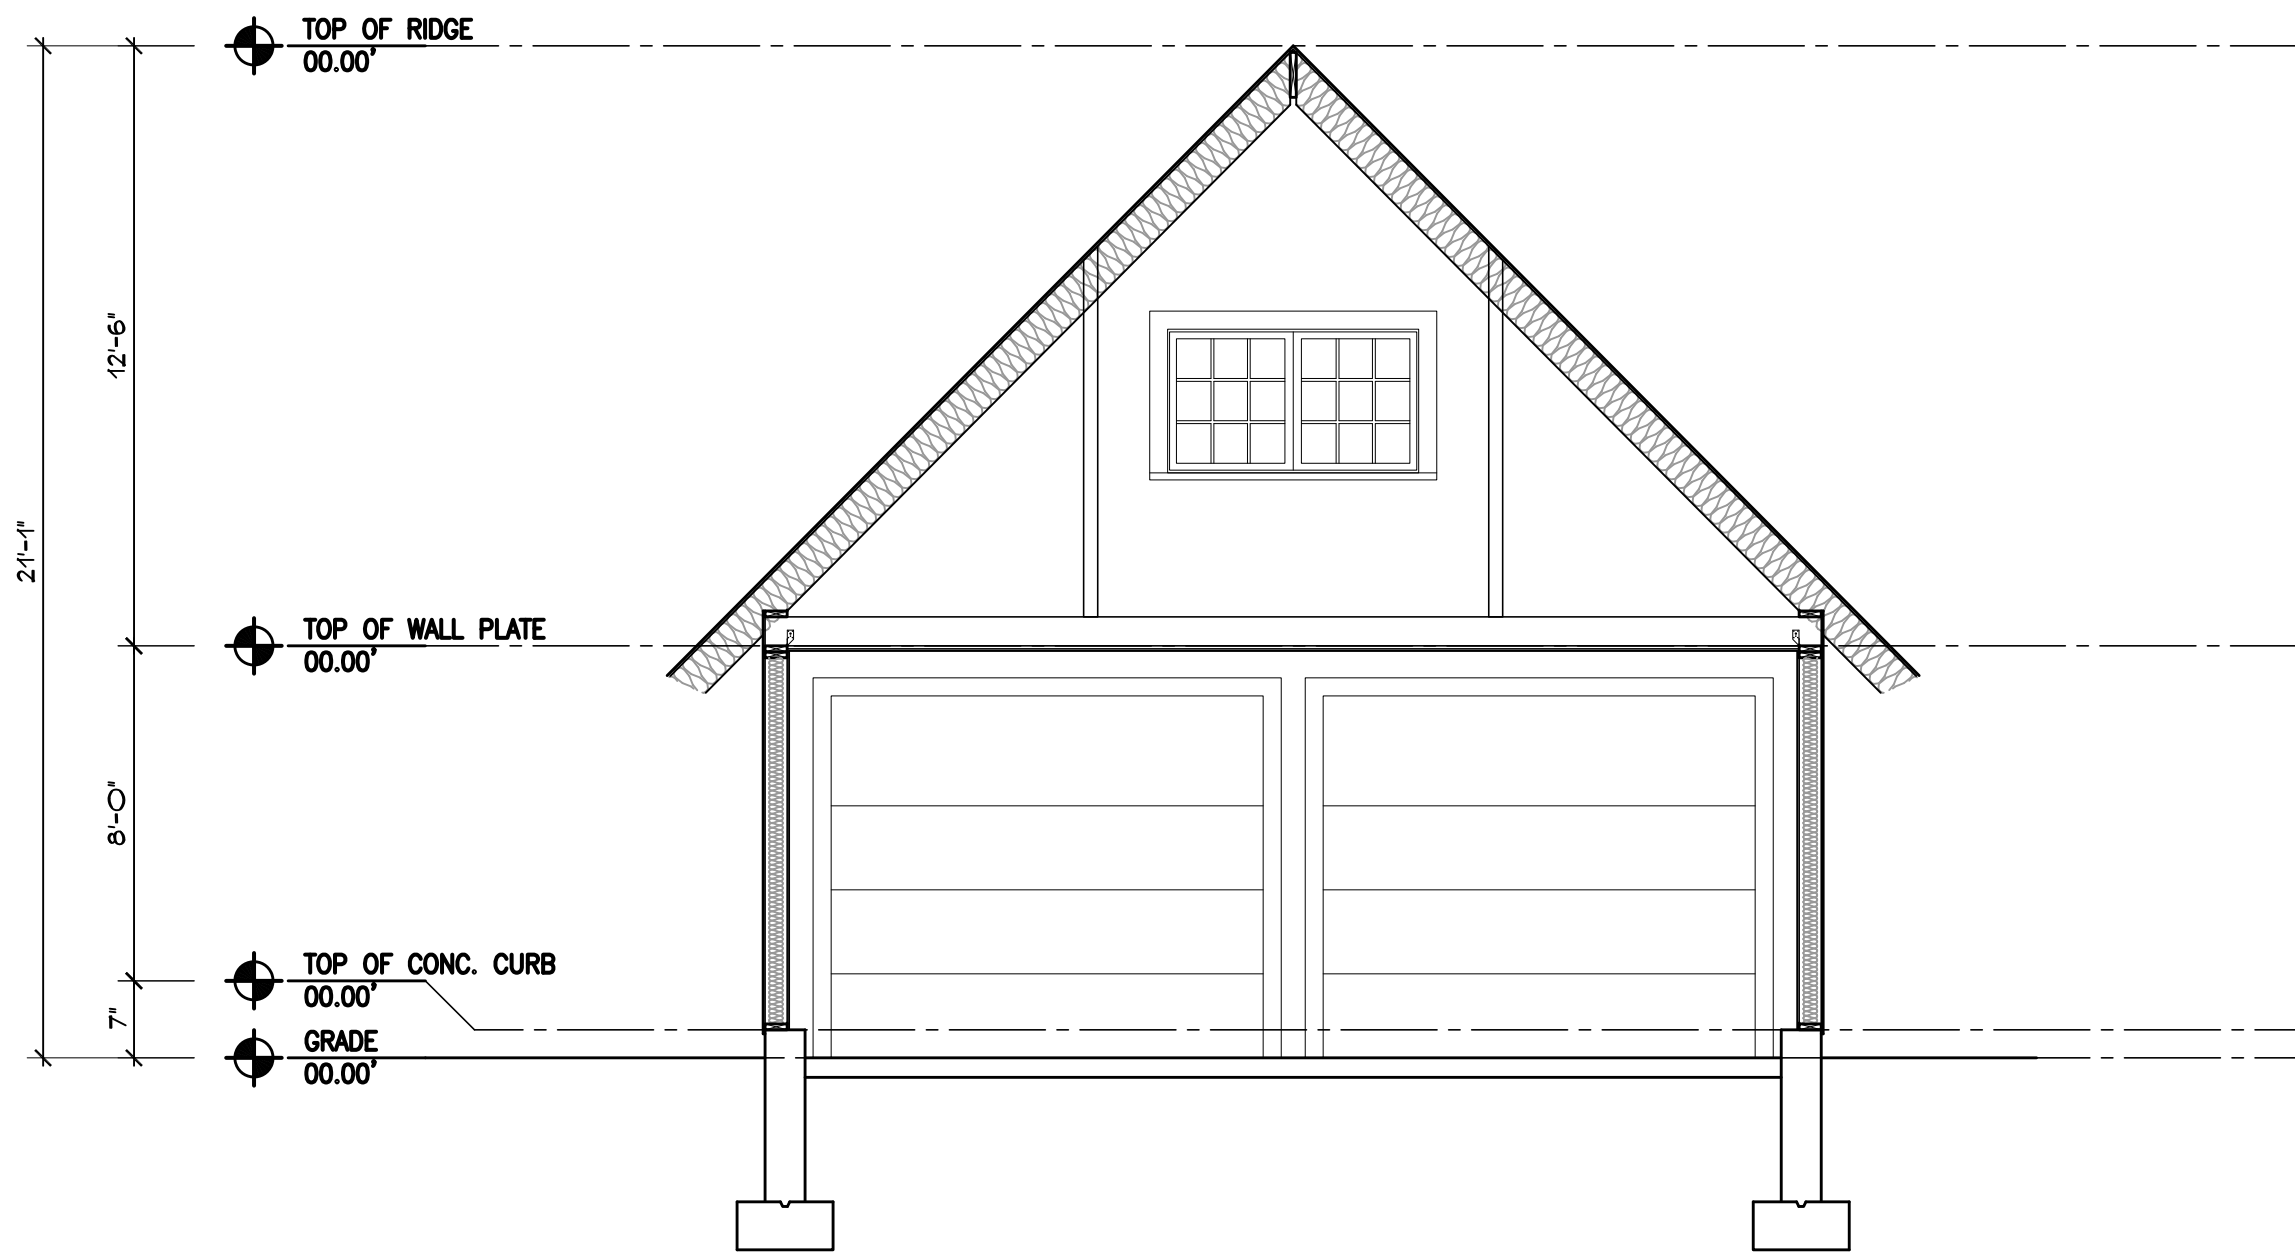2



A

B

Screened-in Porch Sections

Scale: 1/4" = 1'- 0"

3

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SECTIONS AND DETAIL

Drawing Title:


Drawn By: CT Checked By: GG

A3.0

Drawing Number:

File Name: Scale: AS NOTED

Date: 6/24/2021

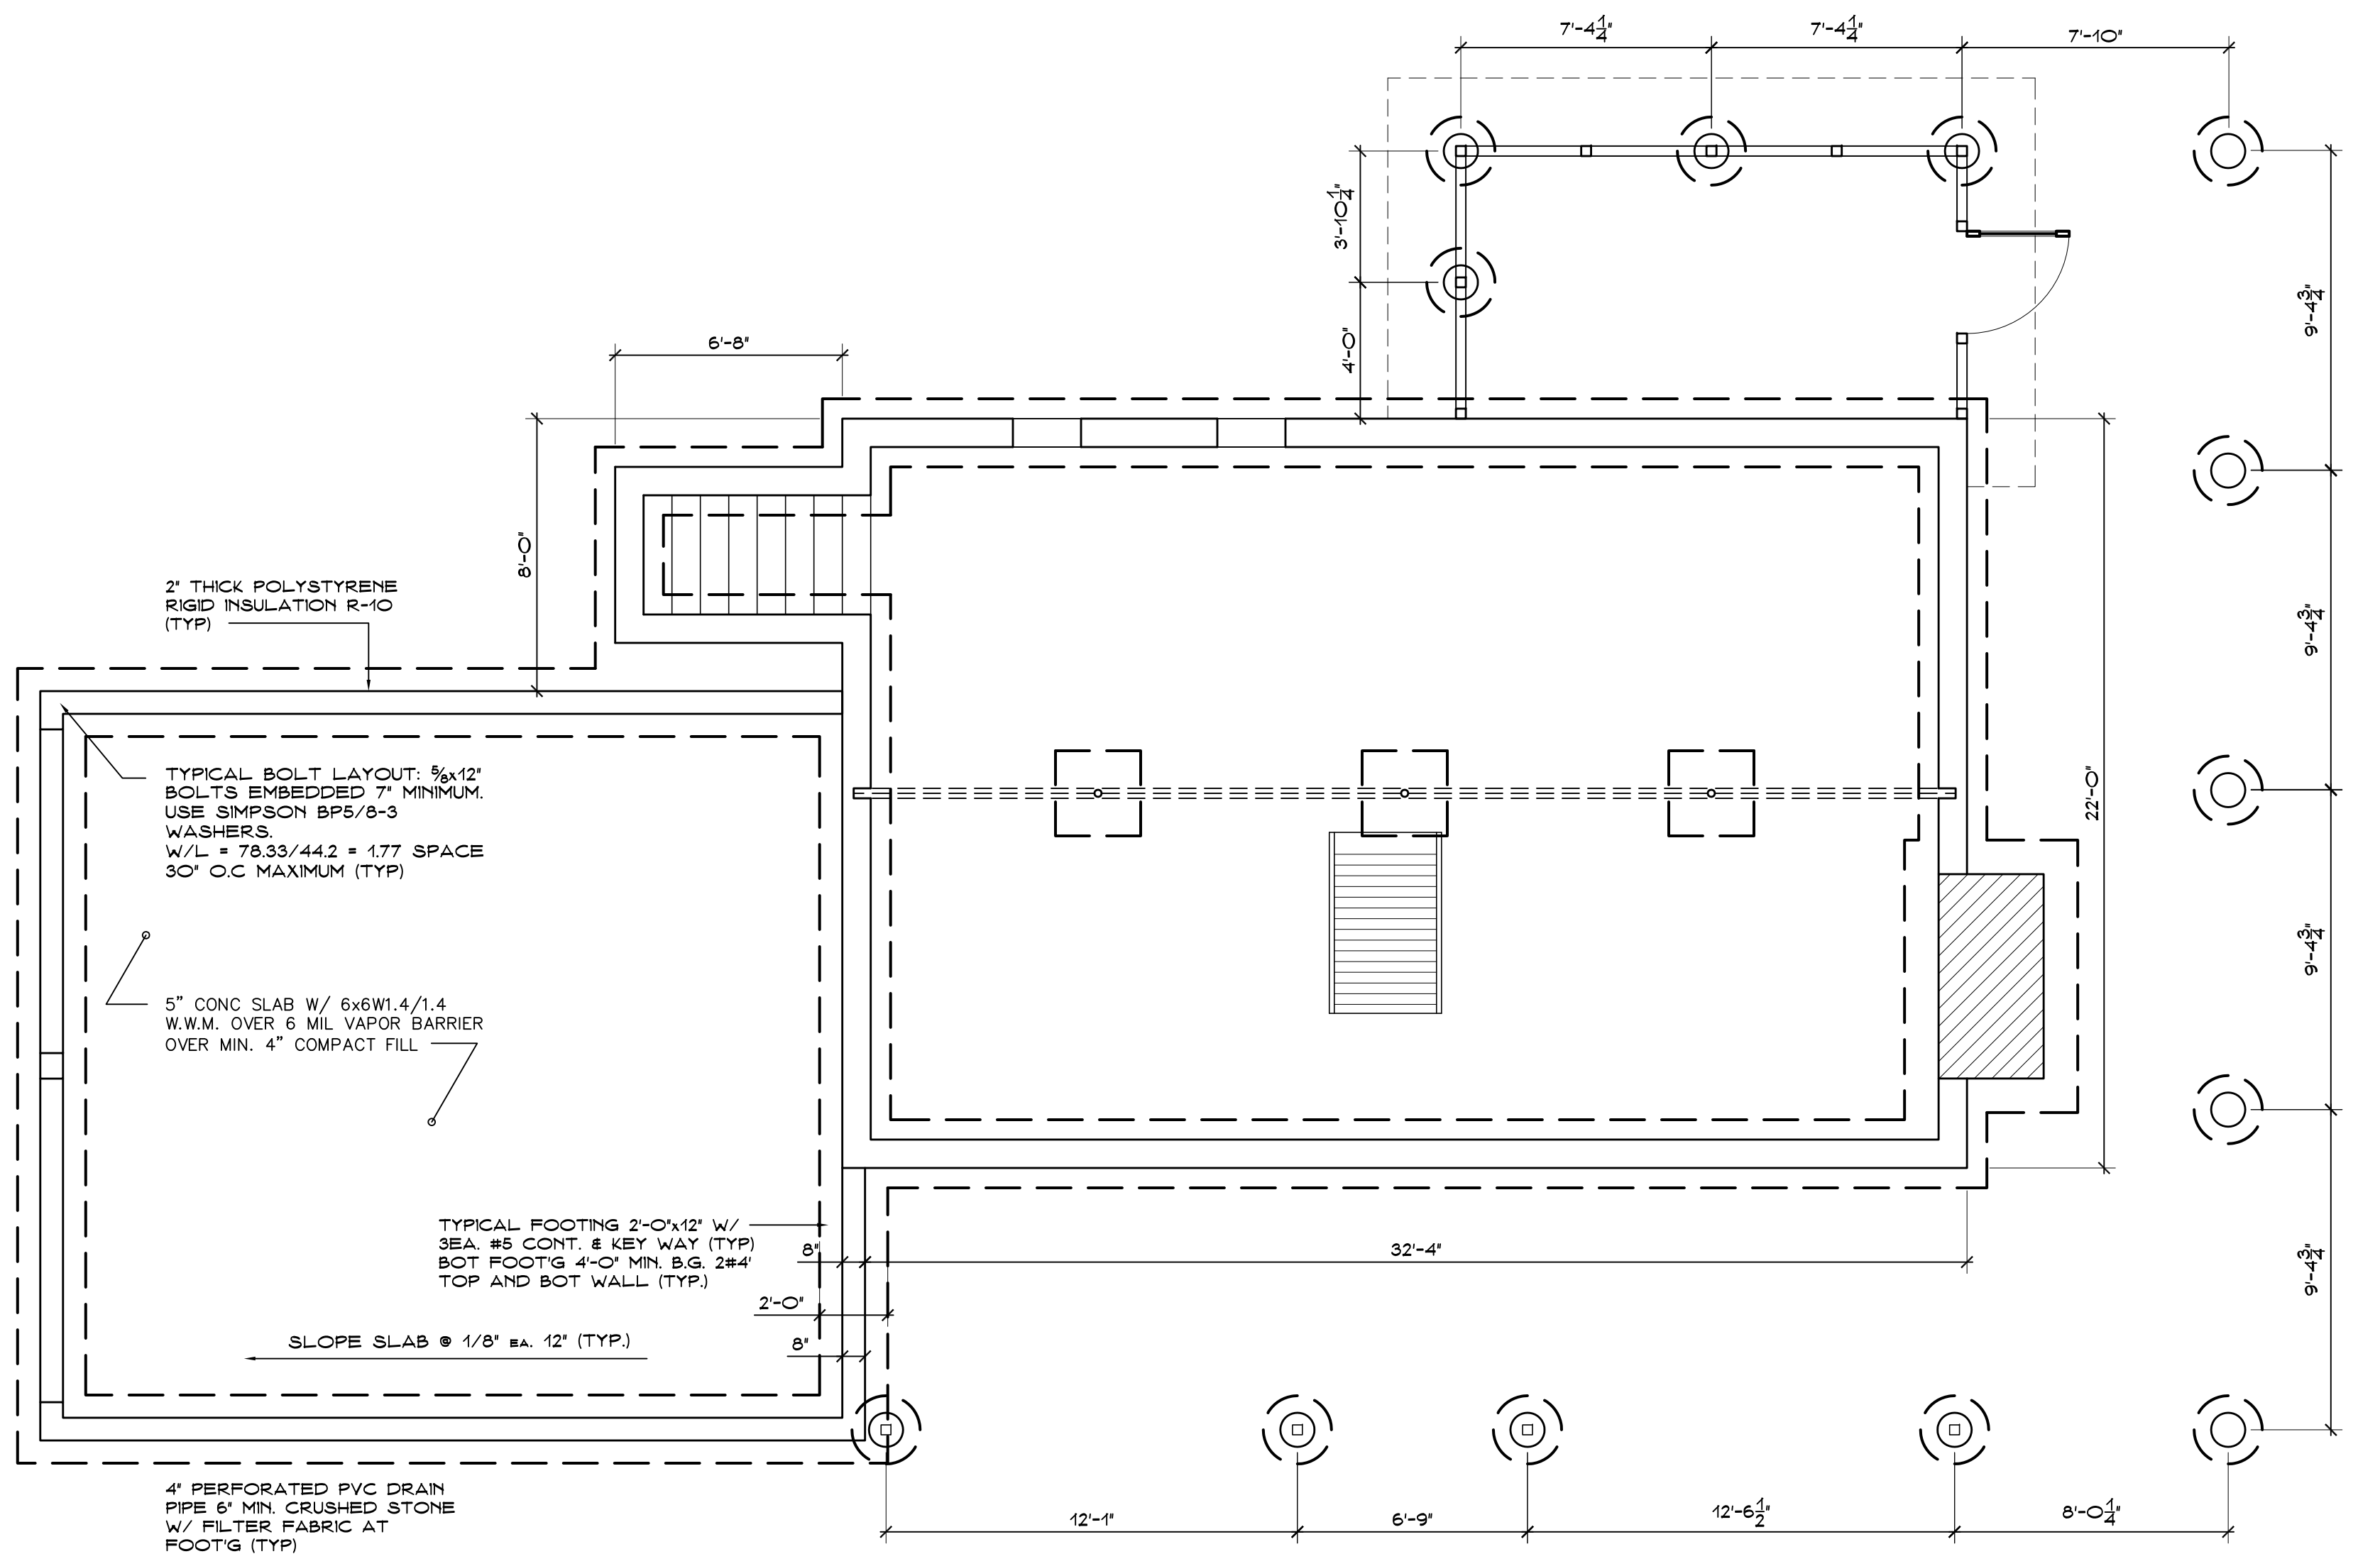

1 Foundation Plan
 Scale: 1/4" = 1'-0"

Project
 7 North Bog Road
 Edgartown, MA 02539

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 103 Beaumont Ave.
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 tel. 617.969.3539
 e-mail dkirsztajn@gmail.com


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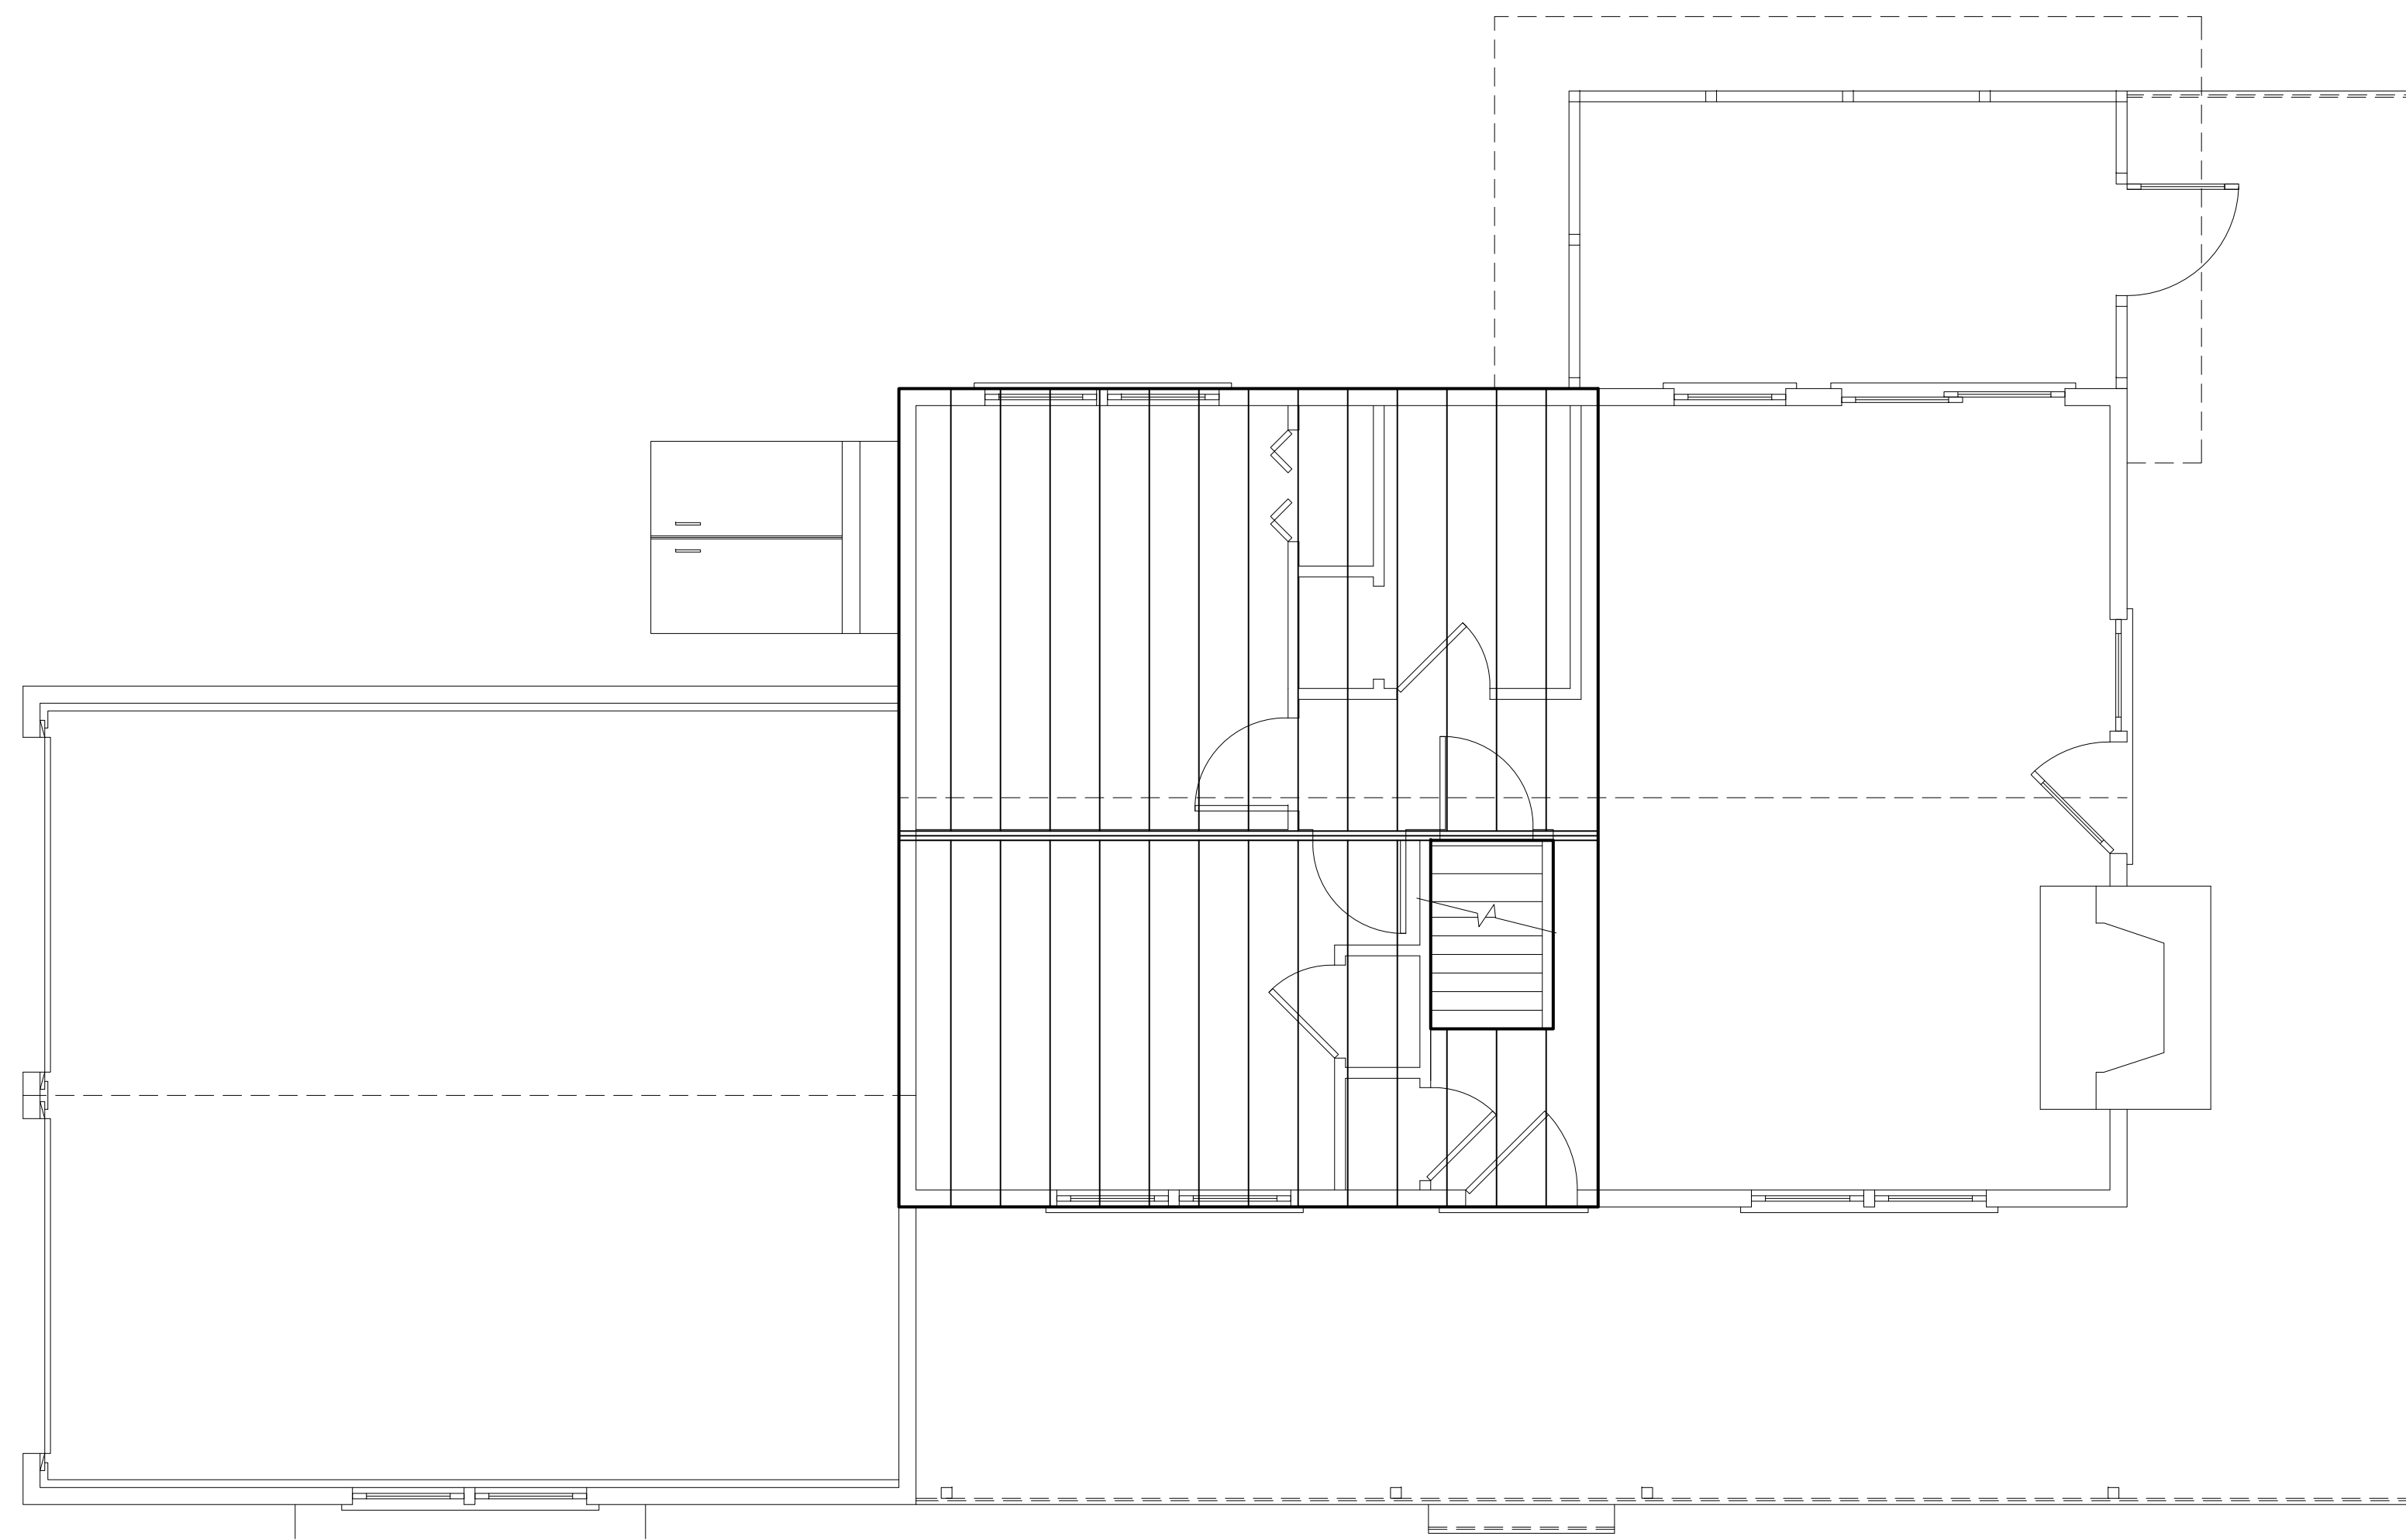
FOUNDATION PLAN

Drawing Title:
 Drawn By: CT Checked By: GG

S0.1
 Drawing Number:
 File Name: Scale: AS NOTED
 Date: 6/24/2021



1 First Floor Structure Plan
Scale: 1/4" = 1'-0"

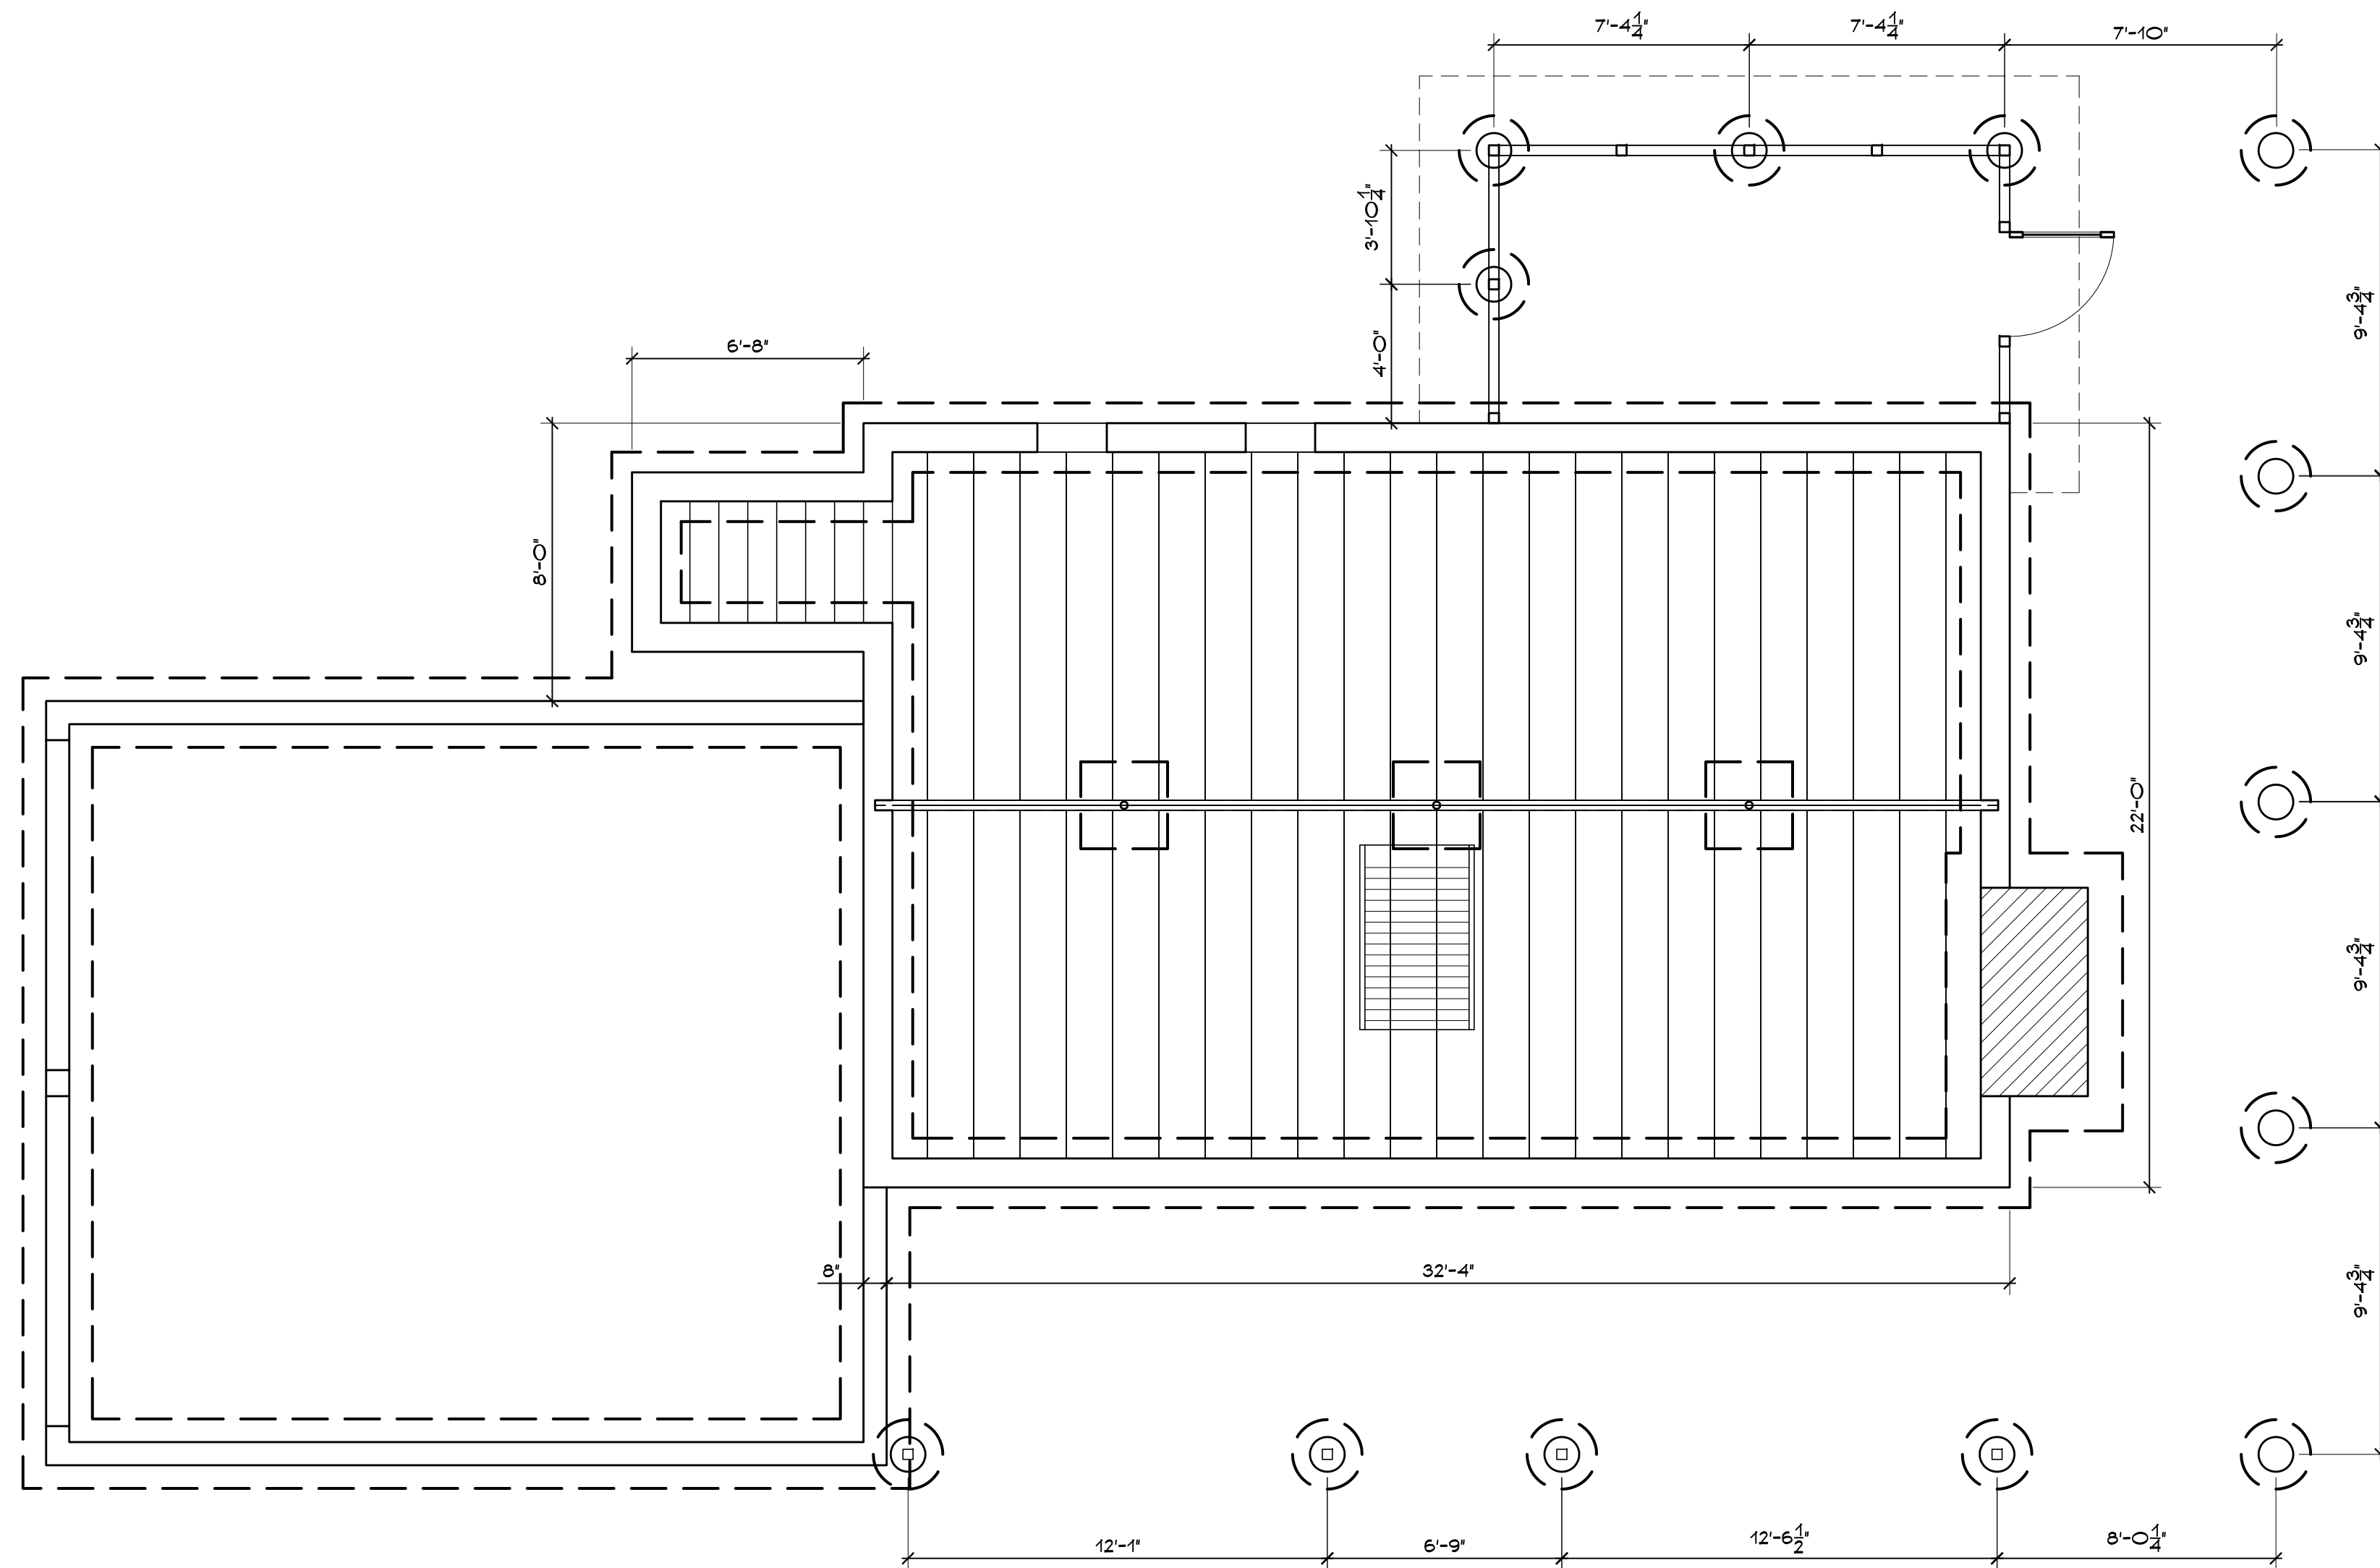

1 Loft Structure Plan
Scale: 1/4" = 1'-0"

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02539

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e-mail dkirsztajn@gmail.com

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FIRST & SECOND FLOOR FRAMING PLAN

Drawing Title:


Drawn By: CT Checked By: GG

S1.0

Drawing Number:

File Name: Scale: AS NOTED

Date: 6/24/2021

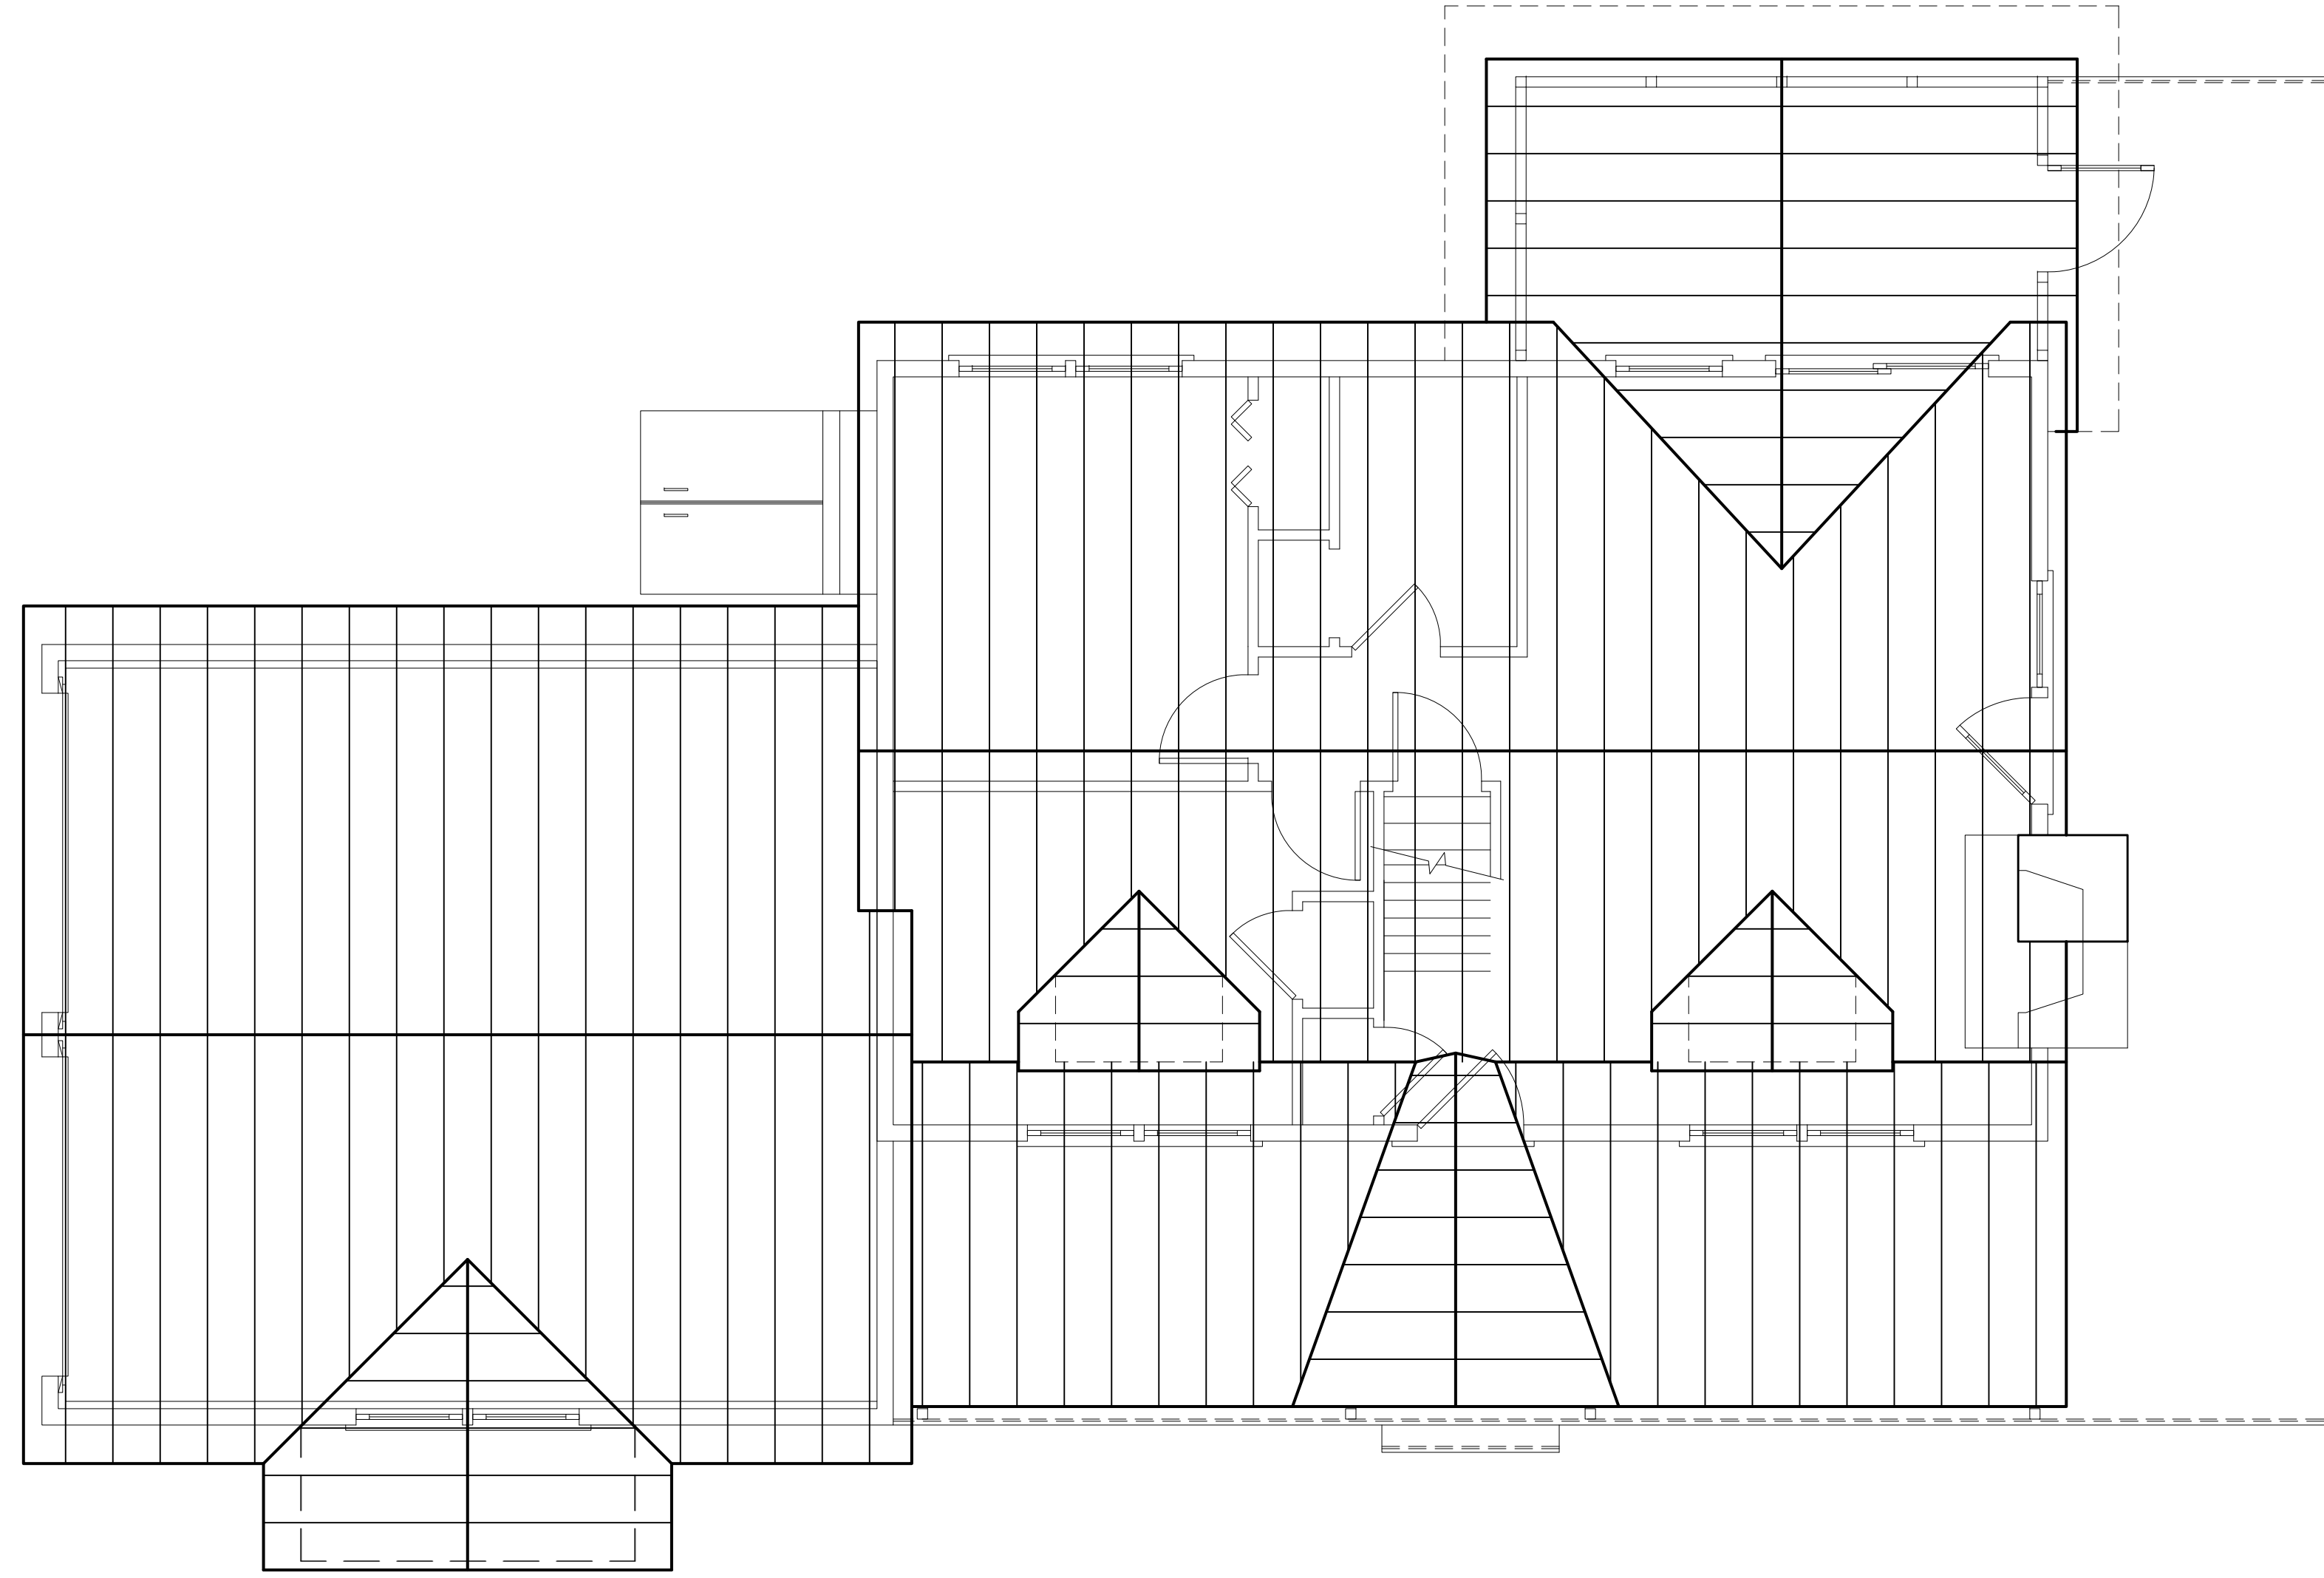

① **Roof Framing Plan**
Scale: 1/4" = 1'-0"

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7 North Bog Road

Edgartown, MA
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DESIGN DEVELOPMENT

ROOF FRAMING PLAN

Drawing Title:
Drawn By: CT Checked By: GG

S2.0

Drawing Number:
File Name: Scale: AS NOTED
Date: 6/24/2021

